Sheet List				
Sheet No.	Name			
A10	Zoning			
A11	Site Plan			
A11.1	Site Context Photos			
A11.2	Site Grading Plan			
A11.3	Accessory Details			
A12	Laneway Main Floor			
A13	Laneway Lower Floor			
A14	Roof Plan			
A15	Foundation Plan			
A16	Area Plans			
A17	Front Elevation			
A17.1	Lane Context Photos			
A17.2	Wall Area Diagram			
A18	Left Elevation			
A19	Rear Elevation			
A20	Right Elevation			
A21	Front and Left Materials			
A22	Rear and Right Materials			
A23	Section 1			
A23.1	Crawlspace Section			
A24	Section 2			
A25	Assemblies			
A25.1	Details 1			
A25.2	Details 2			
A25.3	Details 3			
A26	Laneway 3D Views			
A26.1	Laneway 3D Views			
A27	Main House Rear			
A27.1	Main House Rear Photos			
A28	Site Service Plan			
A29	Shadow Study Winter			
A30	Shadow Study Spring			
A31	Shadow Study Summer			
A32	Shadow Study Fall			
A33	Tree Protection Plan			

SCOPE OF WORK	Project Information				
	Property Owner	Wendy Anne Norma	n		
New Laneway House	Site Address	914 Fourth Street, Ne	ew Westminster		
Built to Step Code 3	Project Type	New Laneway House	New Laneway House		
·	Jurisdiction Authority	City of New Westmin	ster		
	Legal Description	Lot 24, New West Di Block 14, EXC PCL			
	PID	008-163-383			
	Zone	RS-1			
	CONSULTA	NTS			
City Request	Surveyor	Elevate Land surveying	Elevate Land surveying 604-385-5		
' '	Designer	D3 Design	6	04-603-6747	
Extending past the Laneway envelope	Engineer				
A104	Builder				
A105	Energy Consultant				
2. Site Coverage 11.3% 714.8 SF	Arborist				
A101 A108	Zoning Analys	sis			
	Site				
	Lot Width	West: 132.05 ft.   East: 132.04 ft.			
PLAN # 1610	Lot Depth	South: 47.98 ft.   North: 47.96 ft.			
12/11/11/10/10	Lot Size	6333.97 ft <sup>2</sup>			
These drawing copies or any copies thereof:					
-May only be issued be issued by D3 Dimension Drafting Design Ltd.	Laneway House	Required/Allowed	Proposed	Notes	
-May only be issued for the designated purpose indicated -Are issued with the understanding that D3 Dimension Drafting	Main Floor		N/A		
Design Ltd., will be responsible for their work only to the extent of issuing corrected copies in the event of an error or omission of the	Lower Floor		N/A		
same.	Total Floor area	(16%)1013.5 ft <sup>2</sup>	(15.6%)983.55	t <sup>2</sup> 310.19.(a)	
-All work done by D3 Dimension Drafting Design Ltd., is and will remain solely the property of the same.	Site Coverage	(10%) 633.4 ft <sup>2</sup>	(11.2%)709.60	t <sup>2</sup> Relaxation	
-All funds paid are non-refundable.	Carport	226 ft <sup>2</sup>	190 ft <sup>2</sup>	310.17.(a)	
	Front Entry Landing	32 ft <sup>2</sup>	26 ft <sup>2</sup>	310.17.(b)	

Deck

Bicycle Storage

Setbacks

West Lot

East Lot

Private Outdoor Space

Primary Separation

**Building Envelope** 

Base Height Plane

Accessory Height

Floor Area

Site Coverage

West envelope midpoint

East envelope midpoint

# GENERAL NOTES

These drawings have been prepared by D3 Dimension Drafting and Design Inc. to conform to the current residential standards of the BCBC (2018).

The Builder is responsible for ensuring that all construction conforms to provincial and local codes and bylaws

Dimensions take precedence to scale drawings.

Dimensions to be taken from outside face of sheathing for exterior walls and face of studs for interior walls as

Place footings to undisturbed, sound bearing soil below frostline (2' below grade).

Structural lumber to be No.2 SPF or better

Between all exterior top plates and double plates, require 6 MIL poly.

6 MIL poly is required at all connection points between interior and exterior walls

Floor assembly to be constructed with manufacture I-Joist

Lumber in contact with concrete to be damproofed (sill gasket) , and anchored with 1/2" anchor bolts at 16" O.C.

Lintels to be #2-2x10 U.N.O TYP.

Double joists at parallel partitions (opt. 2x10 blocking at 24" O.C.)

Dwelling must meet current B.C. ventilation code

All operable windows to be standard sliding glazing, U.N.O.

Waterproof wallboard required on bathroom walls

Provide a bond-breaking material between foundation or rock and slabs.

Exterior dimensions to be measured from outside of sheathing.

All interior dimensions to be measured to the centre of stud, except where otherwise noted.

All Construction and installation of materials and equipment shall be done in accordance with good building practices, following manufacturers instructions and conforming to the BCBC

All Structural specifications to be designed and certified by a structural engineer. Any discrepancies must be brought to D3 Dimension Drafting and Design Inc. attention.

It is the responsibility of the contractor or builder to check and verify all dimensions and to ensure all work conforms to all local bylaws ad regulation, and to the current edition of the BCBC

D3 Dimension Drafting and Design Inc. accepts no liability for error or omissions

These plans conform to the B.C. Building Code, 2018 ED.

310.17.(c)

310.17.(d)

Notes

Notes

Notes

310.11

310.13.(d)

35 ft<sup>2</sup>

32 ft<sup>2</sup>

185 ft<sup>2</sup>

3.00'

49 24

4.50'

4.88'

265 89

265.49'

265.69'

16 85'

Existing

(26.9%)1704 ft<sup>2</sup>

(15.7%)993 ft<sup>2</sup>

Proposed

Proposed

No retaining wall shall be constructed on any lot having an exposed height greater than 4

ft. unless engineered
Any exposed concrete over 2 ft in height shall be architecturally treated.

No exposed concrete block is permitted

Exposed concrete foundation walls are not to exceed 1.64 ft in height,
In General, the main materials used on the front of the house should be used on all other

Overhangs to be a minimum of 18" TYP. U.N.O.
All gable fascia shall be a minimum fascia of 2x10.

#### Roof & Building Materials

Any fascia gutter must be properly integrated with wood fascia boards to meet building Exterior vertical walls are to be non-combustible 20min rated

The garage shall have closing doors with raised panels or desired architectural detailing

Garage should be painted to match proposed buildings design and colour scheme Garage dimensions are taken from the outside of cladding.

Driveways shall be constructed of permeable materials or U.N.O.

No gravel driveways or parking areas.

No buildings or driveways shall be constructed on the lots unless provisions to reduce storm water run-off from buildings and driveways been made by the run-off from buildings, driveways and any other impervious surfaces constructed on the lot being re-charged back to the ground through suitable subsurface storm water management systems such as rock pits or exfiltration chambers and run-off from driveways which slope to the public road or common property being intercepted at the property line by the provision of suitably designed and constructed absorbent strip such as grass-crete or permeable interlocking concrete



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### **Slivercrest Custom** Homes and Reno 914 Fourth Street

No.	Description	Date

75.3 ft<sup>2</sup>

32 ft<sup>2</sup>

180 ft<sup>2</sup> Min.

16 00 ft

4.00 ft

4.00 ft

22 97' (7m)

(50%)3166 ft<sup>2</sup>


(35%)2216 ft<sup>2</sup>

Main House (Unchanged) Required/Allowed

Required/Allowed


Required/Allowed

Zoning	3		
Project number	1610		
Date	Oct 26, 2023	A10	
Drawn by	JG	,	
Checked by	KS	Scale 1" = 1'-0"	

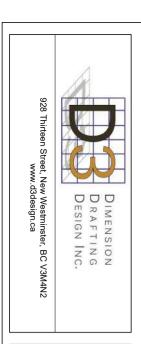


# Slivercrest Custom Homes and Reno

914 Fourth Street

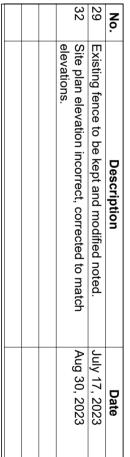



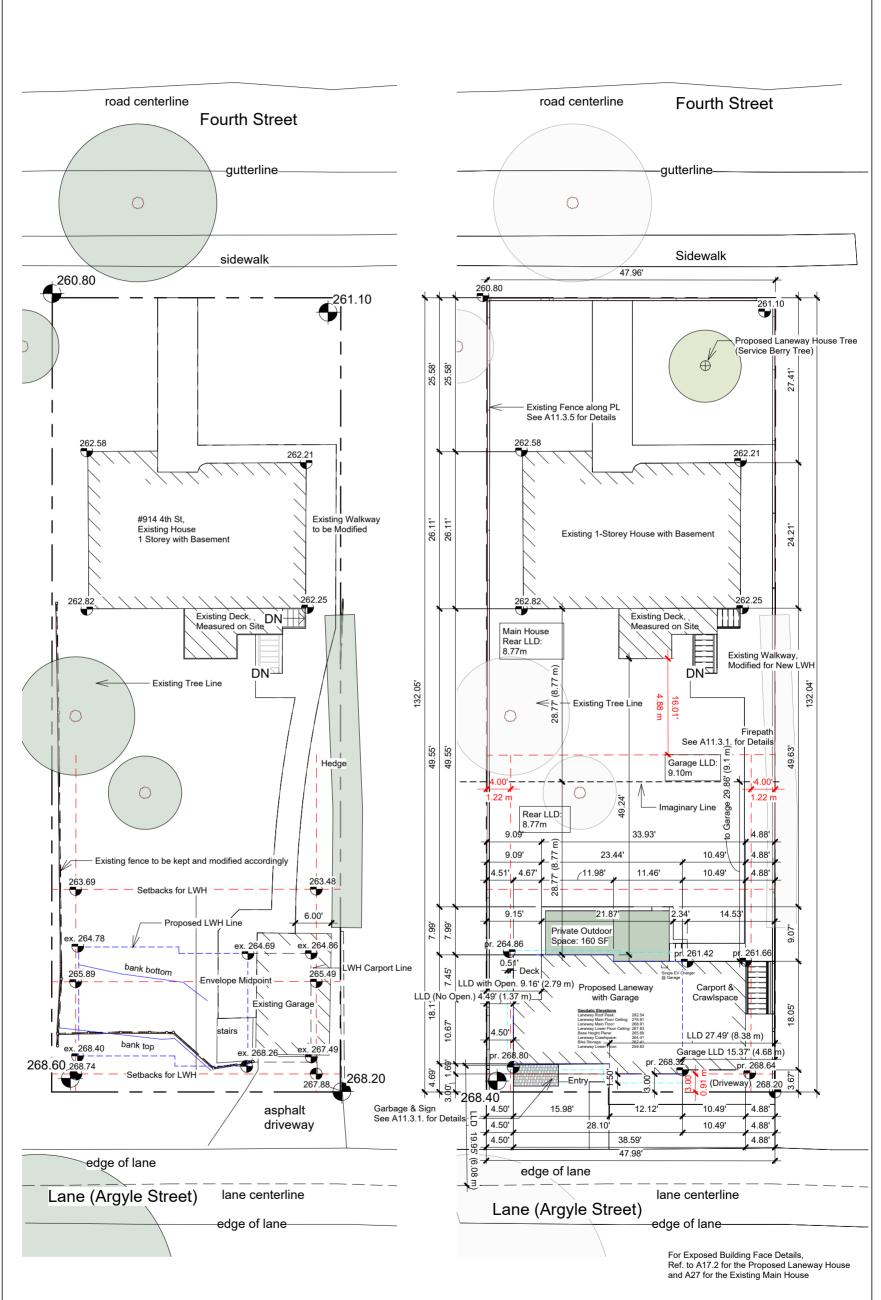

2 Proposed Site 1/16" = 1'-0"

Project North

Existing Site 1/16" = 1'-0"











# Slivercrest Custom Homes and Reno

No.	Description	Date

Site Context Pho	otos	
Project number	1610	
Date	Nov 09,22	A11.1
Drawn by	Author	, , , , , , ,
Checked by	Approver	Scale




# Slivercrest Custom Homes and Reno

No.	Description	Date
32	Site plan elevation incorrect, corrected to match	Aug 30, 2023
	elevations.	

Checked by	Drawn by	Date	Project number 1610	Site G	) ;
Checker	Author	Oct 26, 2023	1610	Site Grading P	: J
Scale 1/16" = 1'-0"	A11.2		Plan		


# **Fourth Street**

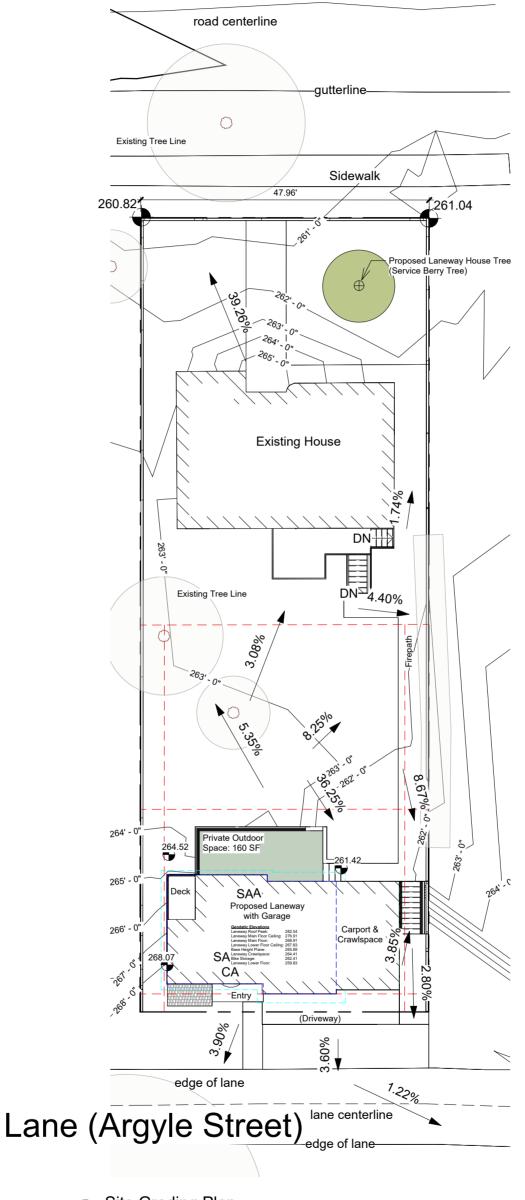


Site Grading Plan
1/16" = 1'-0"






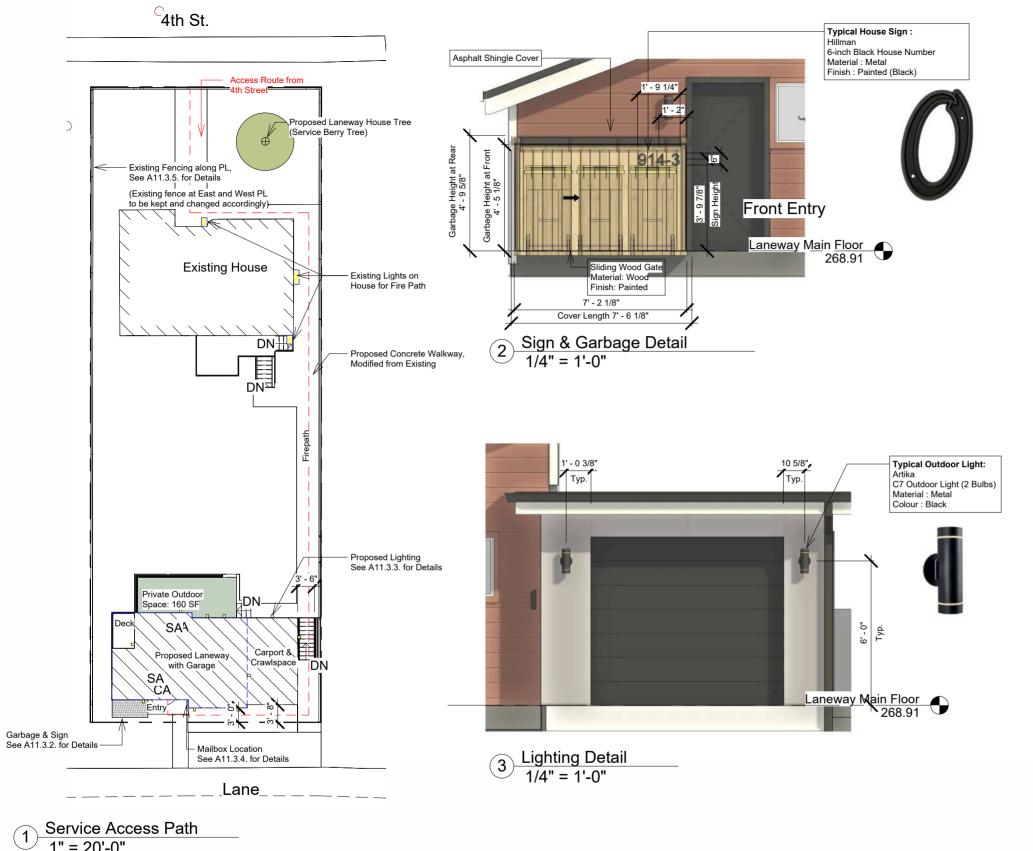

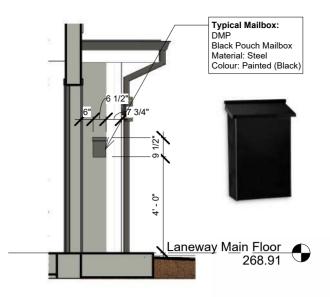

4 Mailbox Details 1/4" = 1'-0"

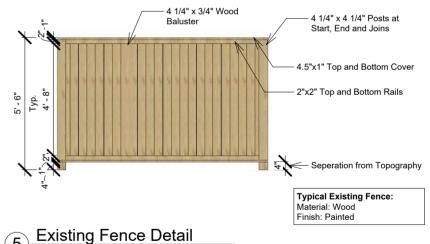

5 Existing Fence Detail
1/4" = 1'-0"


1" = 20'-0"



## **Slivercrest Custom** Homes and Reno 914 Fourth Street

No.	Description	Date
29	Existing fence to be kept and modified noted.	July 17, 2023


Accessory Details		
Project number	1610	
Date	Oct 26, 2023	│ A11.3 │
Drawn by	Author	, (1110
Checked by	Checker	Scale As indicated

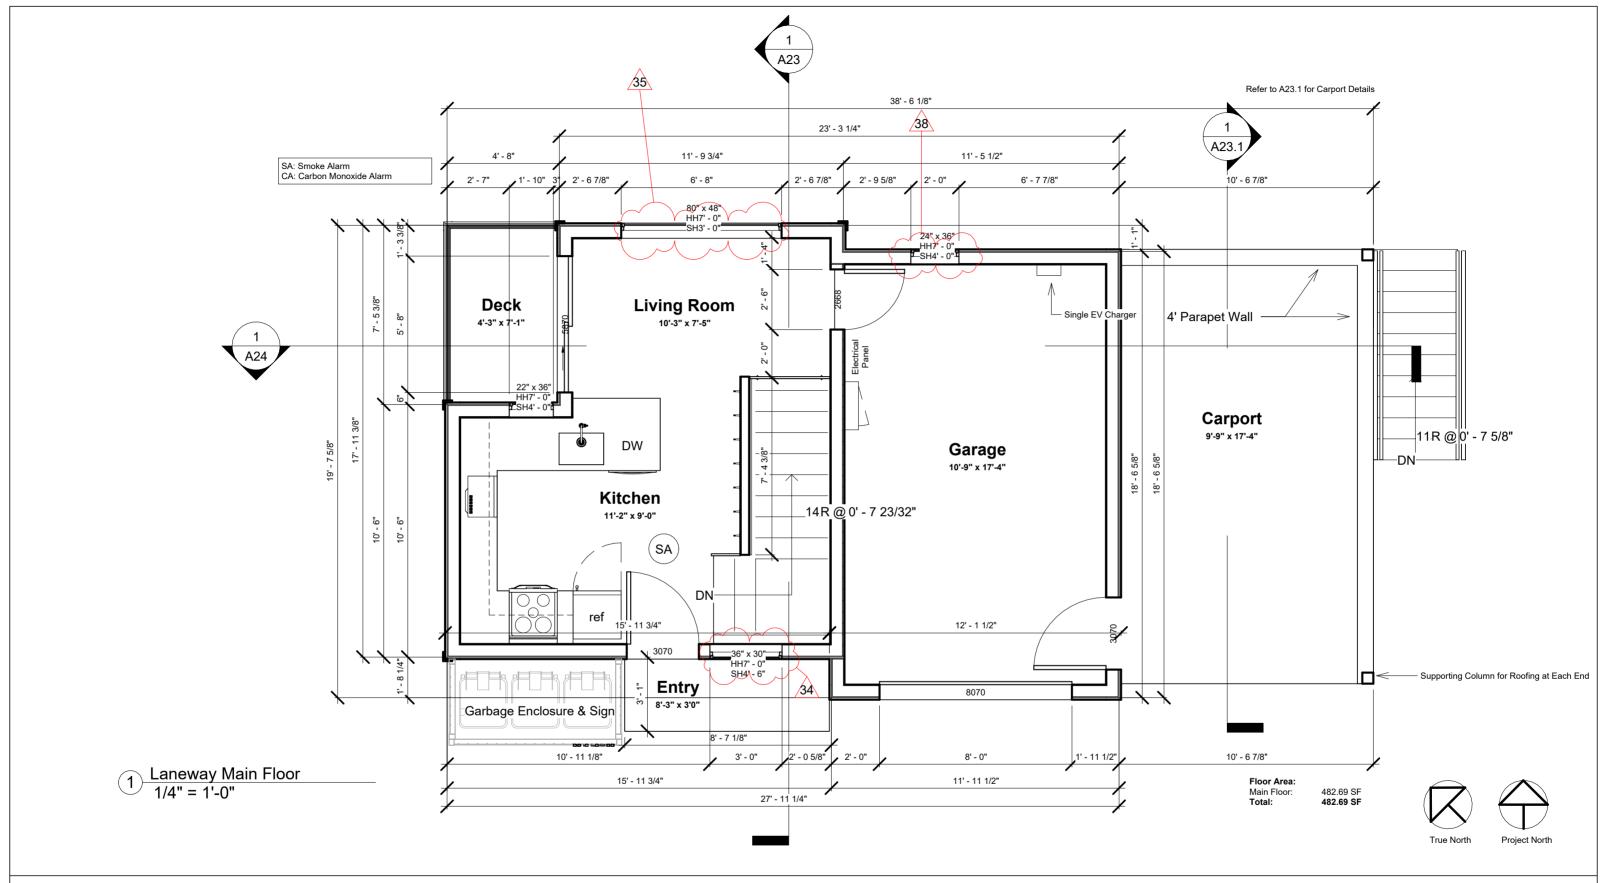



No.	Description	Date
34	Window size changed	October 26, 2023
35	Window size changed	October 26, 2023
38	Window size changed	October 26, 2023

Laneway Main Floor		
1610	1.40	
Oct 26, 2023	A12	
JG	, <b>_</b>	
Checker	Scale 1/4" = 1'-0"	
	1610 Oct 26, 2023 JG	

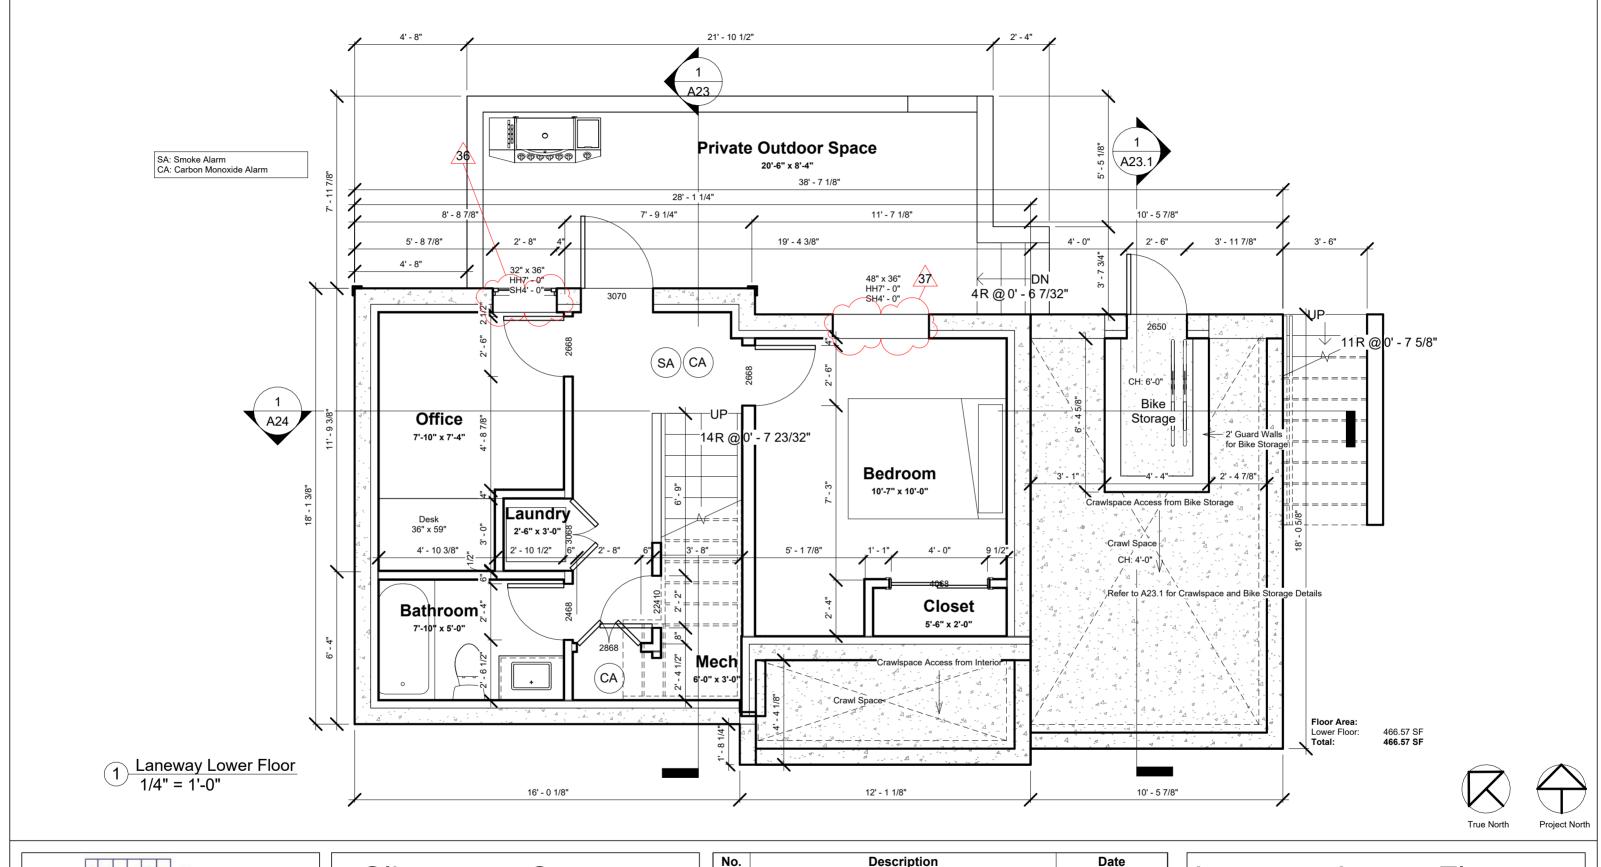




# Slivercrest Custom Homes and Reno

914 Fourth Street

No.	Description	Date
36	Window size changed	October 26, 2023
37	Window size changed	October 26, 2023

# Laneway Lower Floor

Project number	1610	
Date	Oct 26, 2023	A13
Drawn by	JG	7 ( )
Checked by	JG	Scale 1/4" = 1'-0"

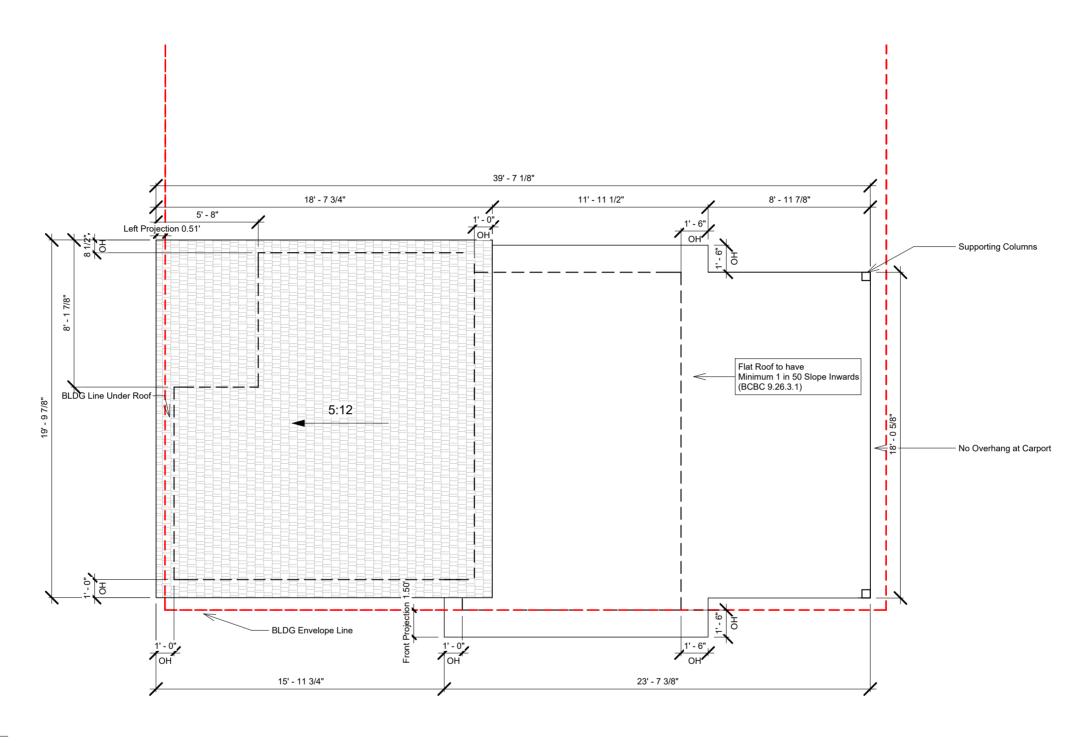



1 Laneway Roof Peak 3/16" = 1'-0"




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## Slivercrest Custom Homes and Reno 914 Fourth Street

No.	Description	Date

Roof F	Plan		
Project number	1610		
Date	Oct 26, 2023	A14	
Drawn by	JG	7	
Checked by	Checker	Scale 3/16" = 1'-0"	

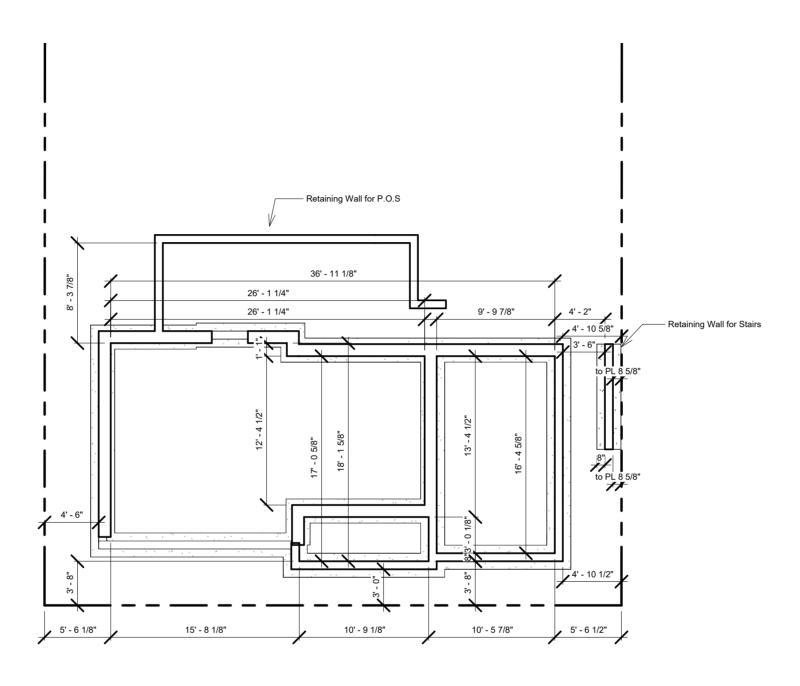

Foundation Plan 1/8" = 1'-0"






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## Slivercrest Custom Homes and Reno 914 Fourth Street

No.	Description	Date

Found	ation Pla	n	
Project number	1610		
Date	Oct 26, 2023	A15	
Drawn by	JG	,	
Checked by	Checker	Scale 1/8" = 1'-0"	



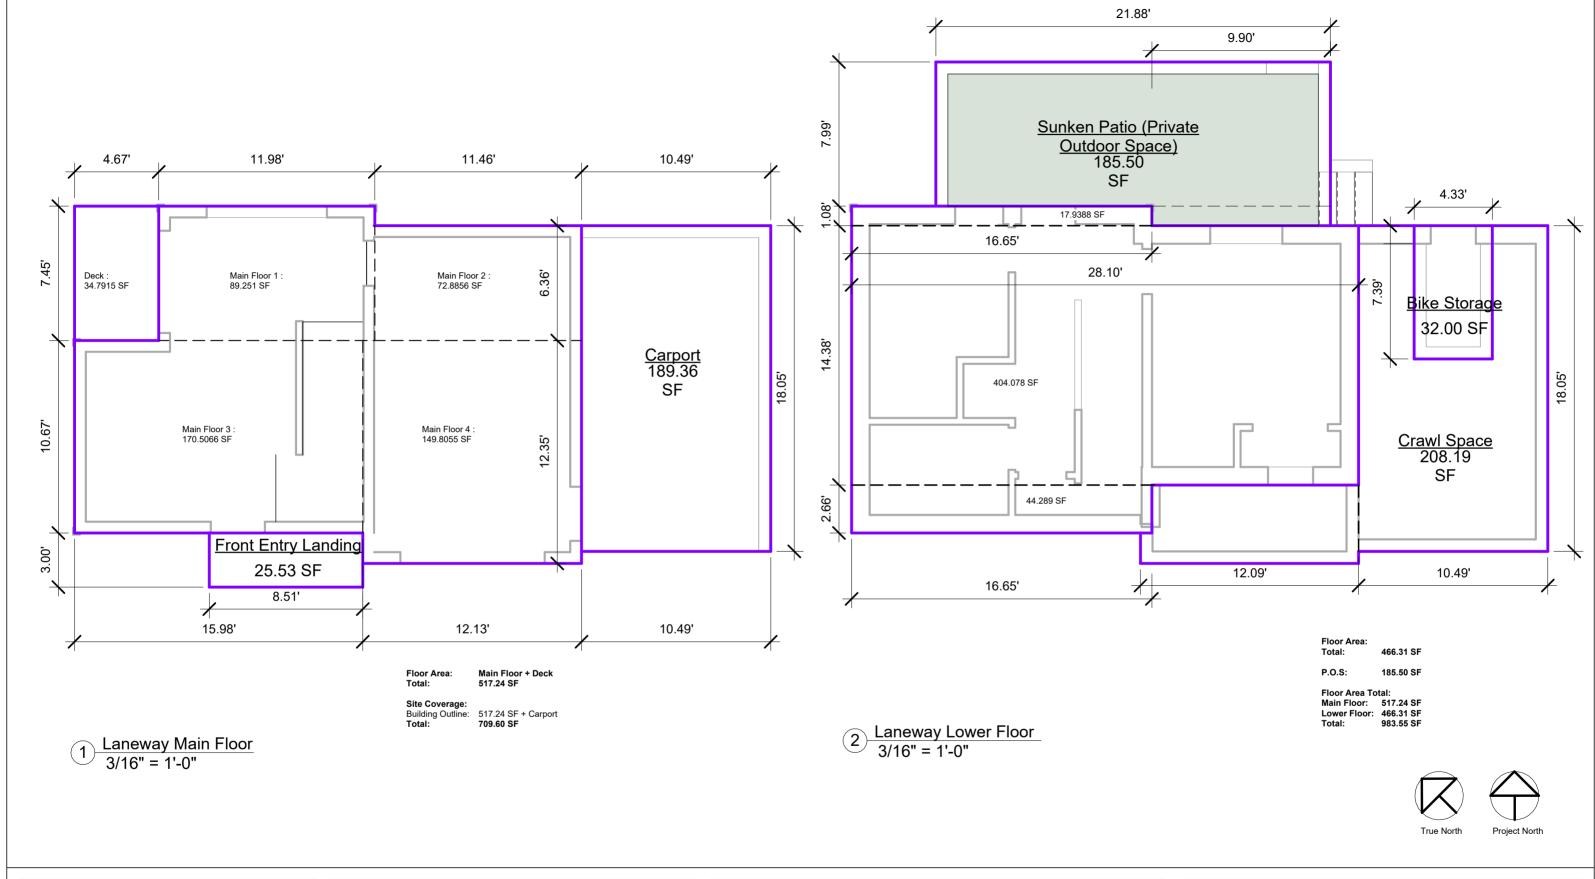


# Slivercrest Custom Homes and Reno

914 Fourth Street	914	Fourth	Street
-------------------	-----	--------	--------

No.	Description	Date

Project number         1610           Date         Oct 26, 2023           Drawn by         JG           Checked by         Checker           Scale 3/16" = 1'-0"	Area F	Plans		
Drawn by JG	Project number	1610		
Drawn by JG	Date	Oct 26, 2023	□ A16	
Checked by Checker Scale 3/16" = 1'-0"	Drawn by	JG		
	Checked by	Checker	Scale 3/16" = 1'-0"	1

27-Oct-2023 04:24:23

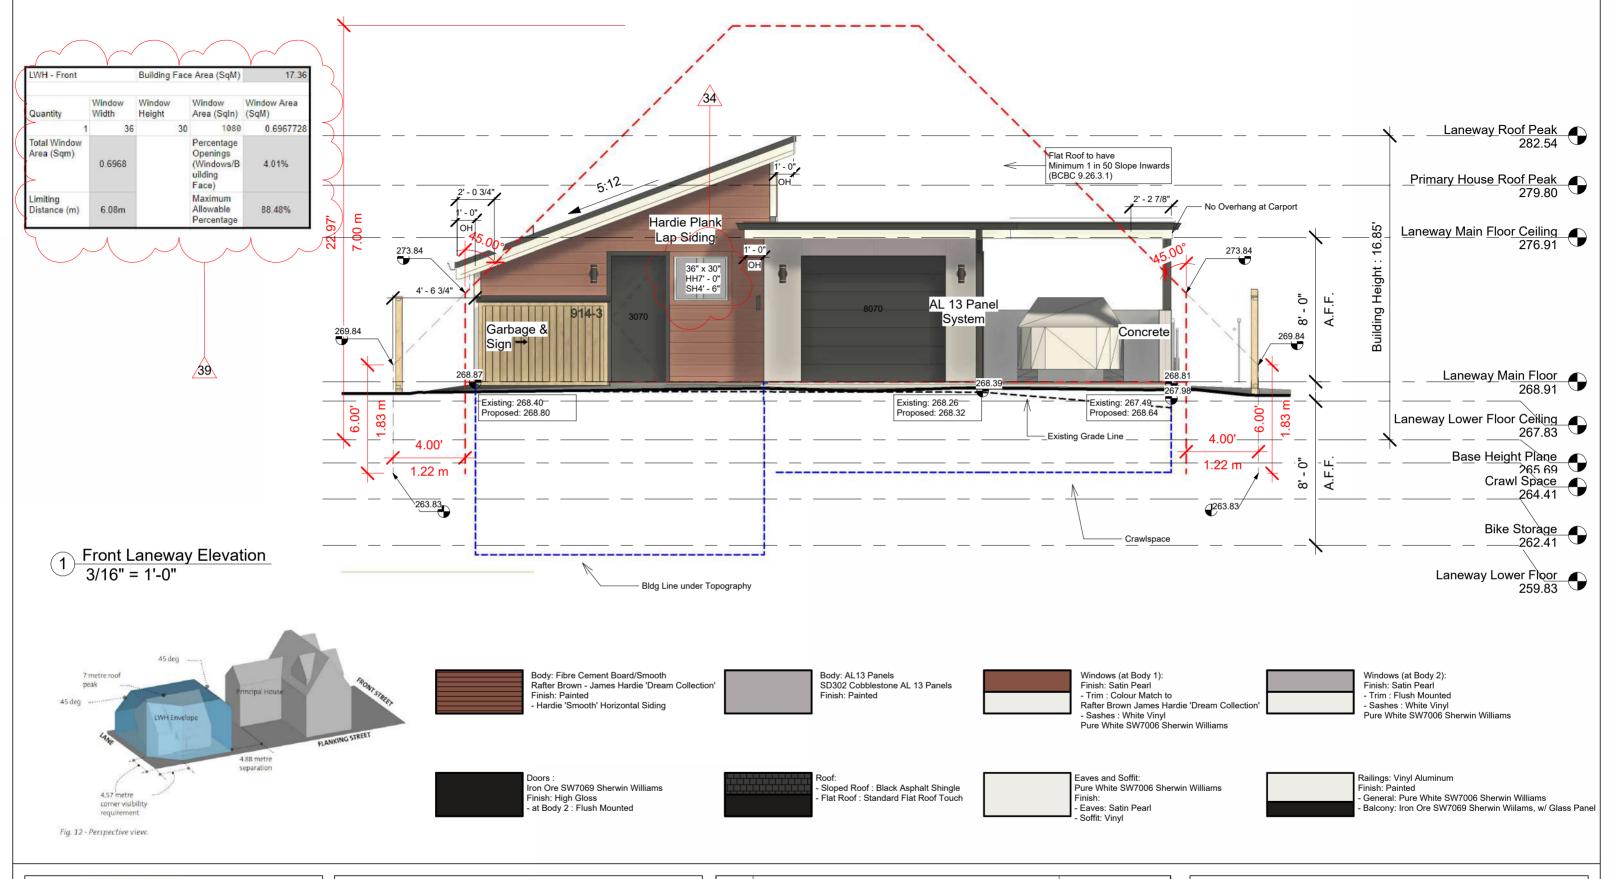



No.	Description	Date
34	Window size changed	October 26, 2023
39	Spatial calculations updated	October 26, 2023

Front I	Elevation		
Project number	1610	N 1 7	
Date	Oct 26, 2023	A17	
Drawn by	JG	7 1 1	
Checked by	JG	Scale As indicated	







Rear Lane Looking North East Looking South West








## Slivercrest Custom Homes and Reno 914 Fourth Street

Description	Date
	Description


Lane Context Photos			
Project number	1610		
Date	Oct 26, 2023	A17.1	
Drawn by	Author		
Checked by	Checker	Scale	ľ
			- 17

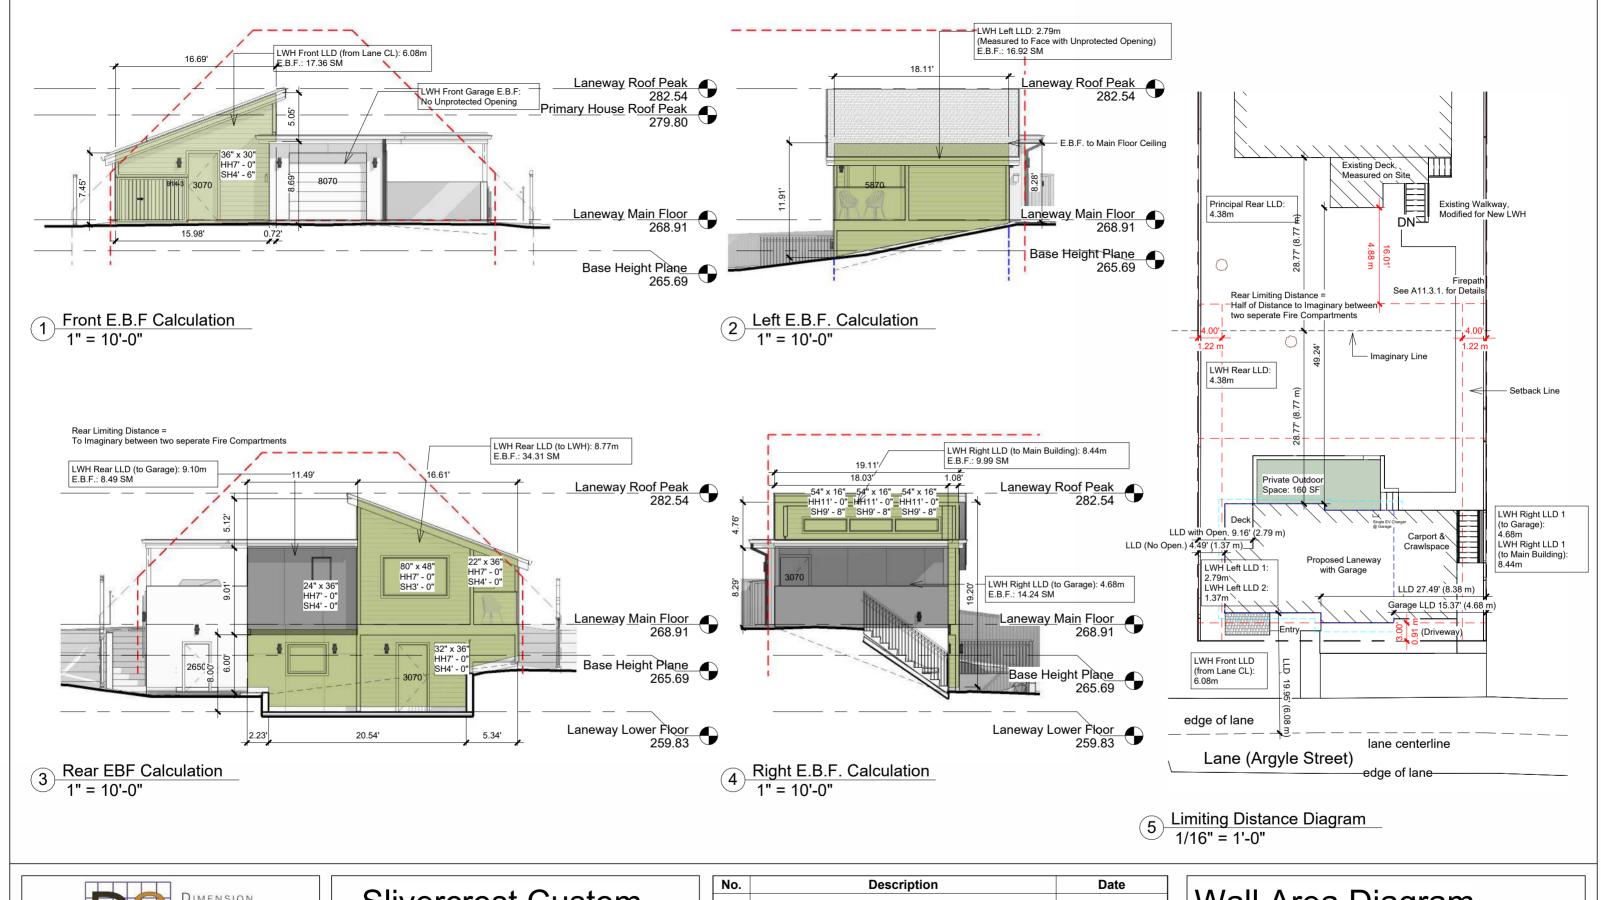



No.	Description	Date

Wall Area Diagram			
Project number	1610		
Date	Oct 26, 2023	□ A17.2 □	
Drawn by	Author	, <del>.</del>	
Checked by	Checker	Scale As indicated	

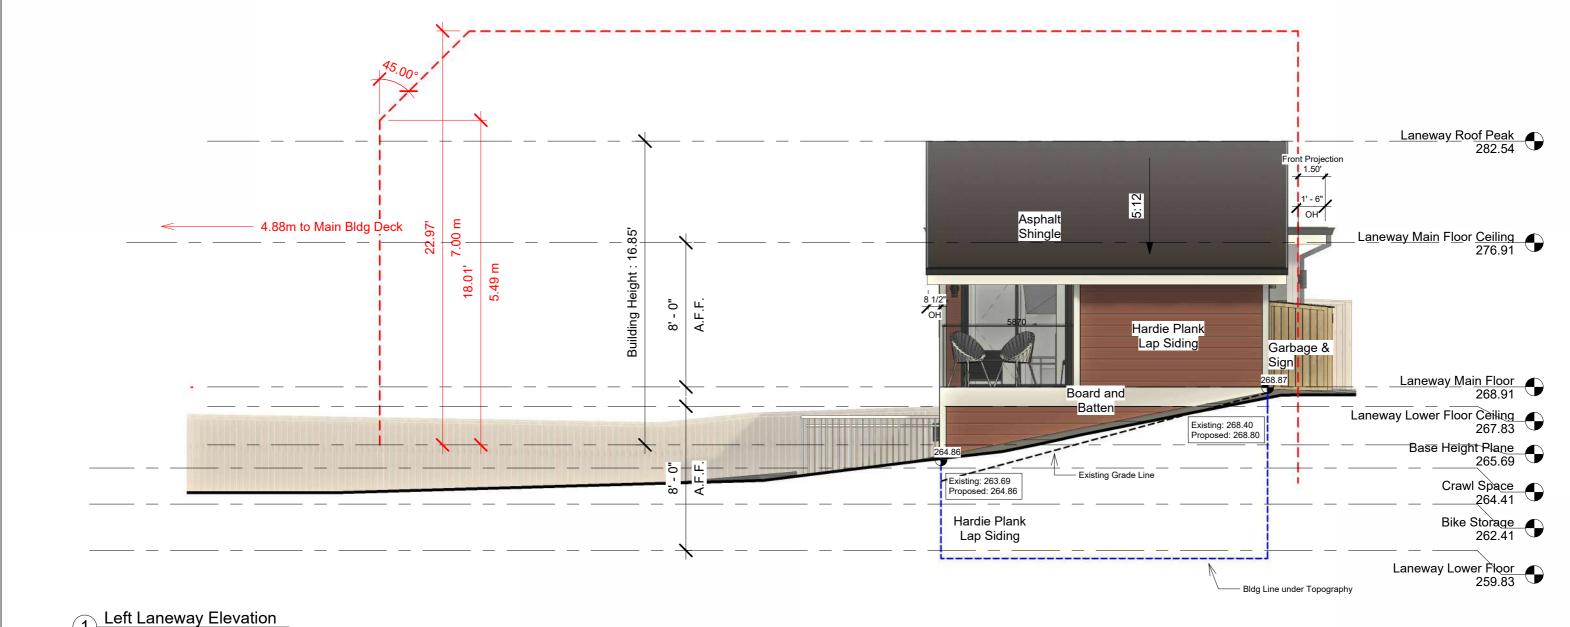


Left Laneway Elevation 3/16" = 1'-0"


LWH - Left		Building Fac	e Area (SqM)	16.92
Quantity	Window Width	Window Height	Window Area (SqIn)	Window Area (SqM)
1	68	84	5712	3.68515392
Total Window Area (Sqm)	3.6852		Percentage Openings (Windows/B uilding Face)	21.78%
Limiting Distance (m)	2.79m		Maximum Allowable Percentage	22.67%



Body: AL13 Panels SD302 Cobblestone AL 13 Panels Finish: Painted

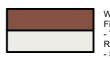

Windows (at Body 1): Finish: Satin Pearl - Trim : Colour Match to Rafter Brown James Hardie 'Dream Collection' - Sashes : White Vinyl Pure White SW7006 Sherwin Williams

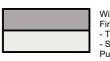

Windows (at Body 2): Finish: Satin Pearl
- Trim : Flush Mounted - Sashes : White Vinyl

Pure White SW7006 Sherwin Williams

ron Ore SW7069 Sherwin Williams Finish: High Gloss - at Body 2 : Flush Mounted

Sloped Roof : Black Asphalt Shingle Flat Roof : Standard Flat Roof Touch

Eaves and Soffit: Pure White SW7006 Sherwin Williams Finish: - Eaves: Satin Pearl

Railings: Vinyl Aluminum Finish: Painted

Finish: Painted - General: Pure White SW7006 Sherwin Williams - Balcony: Iron Ore SW7069 Sherwin Willams, w/ Glass Panel




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# **Slivercrest Custom** Homes and Reno

No.	Description	Date

Left Elevation		
Project number	1610	
Date	May 17, 2023	A18
Drawn by	JG	, (10
Checked by	Approver	Scale As indicated




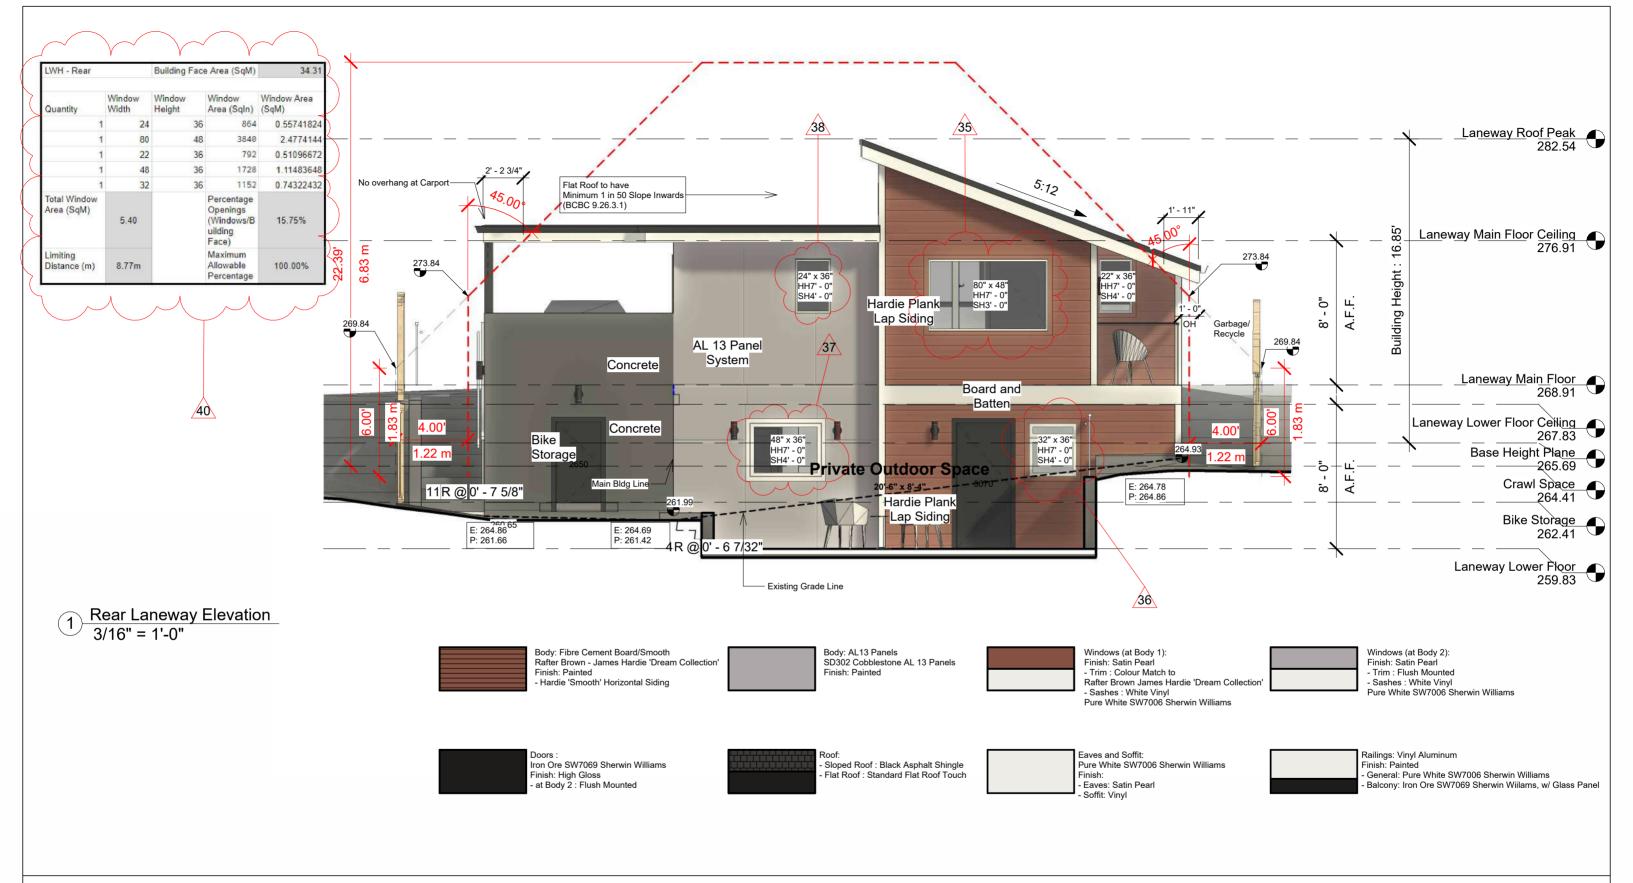


# Slivercrest Custom Homes and Reno

No.	Description	Date
35	Window size changed	October 26, 2023
36	Window size changed	October 26, 2023
37	Window size changed	October 26, 2023
38	Window size changed	October 26, 2023
40	Spatial calculations updated	October 26, 2023

Elevation	
1610	
Oct 26, 2023	A19
JG	
JG	Scale As indicated
	1610 Oct 26, 2023 JG

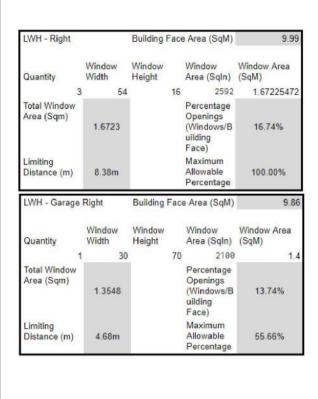

Right Laneway Elevation
3/16" = 1'-0"

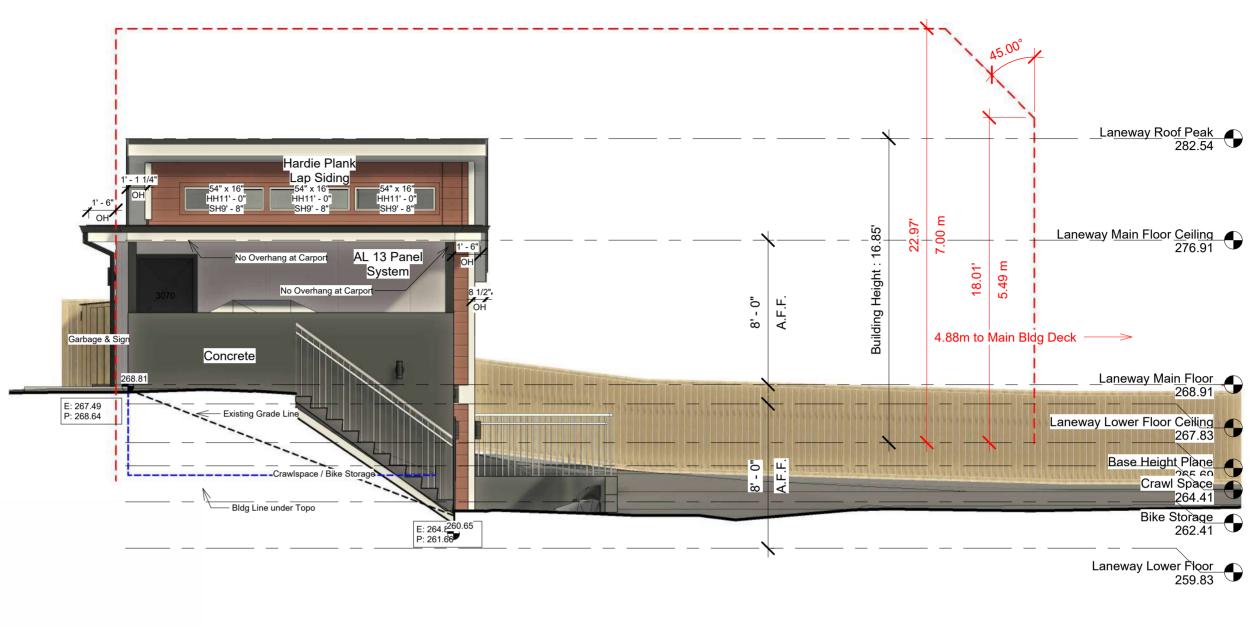



Body: Fibre Cement Board/Smooth
Rafter Brown - James Hardie 'Dream Collection'
Finish: Painted
- Hardie 'Smooth' Horizontal Siding

Body: AL13 Panels SD302 Cobblestone AL 13 Panels Finish: Painted Windows (at Body 1):
Finish: Satin Pearl
- Trim : Colour Match to
Rafter Brown James Hardie 'Dream Collection'
- Sashes : White Vinyl
Pure White SW7006 Sherwin Williams

Win Fini - Tr - Se Pur

Windows (at Body 2): Finish: Satin Pearl - Trim : Flush Mounted

- Sashes : White Vinyl Pure White SW7006 Sherwin Williams



Doors : Iron Ore SW7069 Sherwin Williams Finish: High Gloss - at Body 2 : Flush Mounted



Roof:
- Sloped Roof : Black Asphalt Shingle
- Flat Roof : Standard Flat Roof Touch

Eaves and Soffit:
Pure White SW7006 Sherwin Williams
Finish:
- Eaves: Satin Pearl
- Soffit: Vinyl



Finish: Painted
- General: Pure White SW7006 Sherwin Williams
- Balcony: Iron Ore SW7069 Sherwin Willams, w/ Glass Panel




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# Slivercrest Custom Homes and Reno

No.	Description	Date

Right Elevation			
Project number	1610	100	
Date	Oct 26, 2023	A20	
Drawn by	JG	, 120	
Checked by	JG	Scale As indicated	




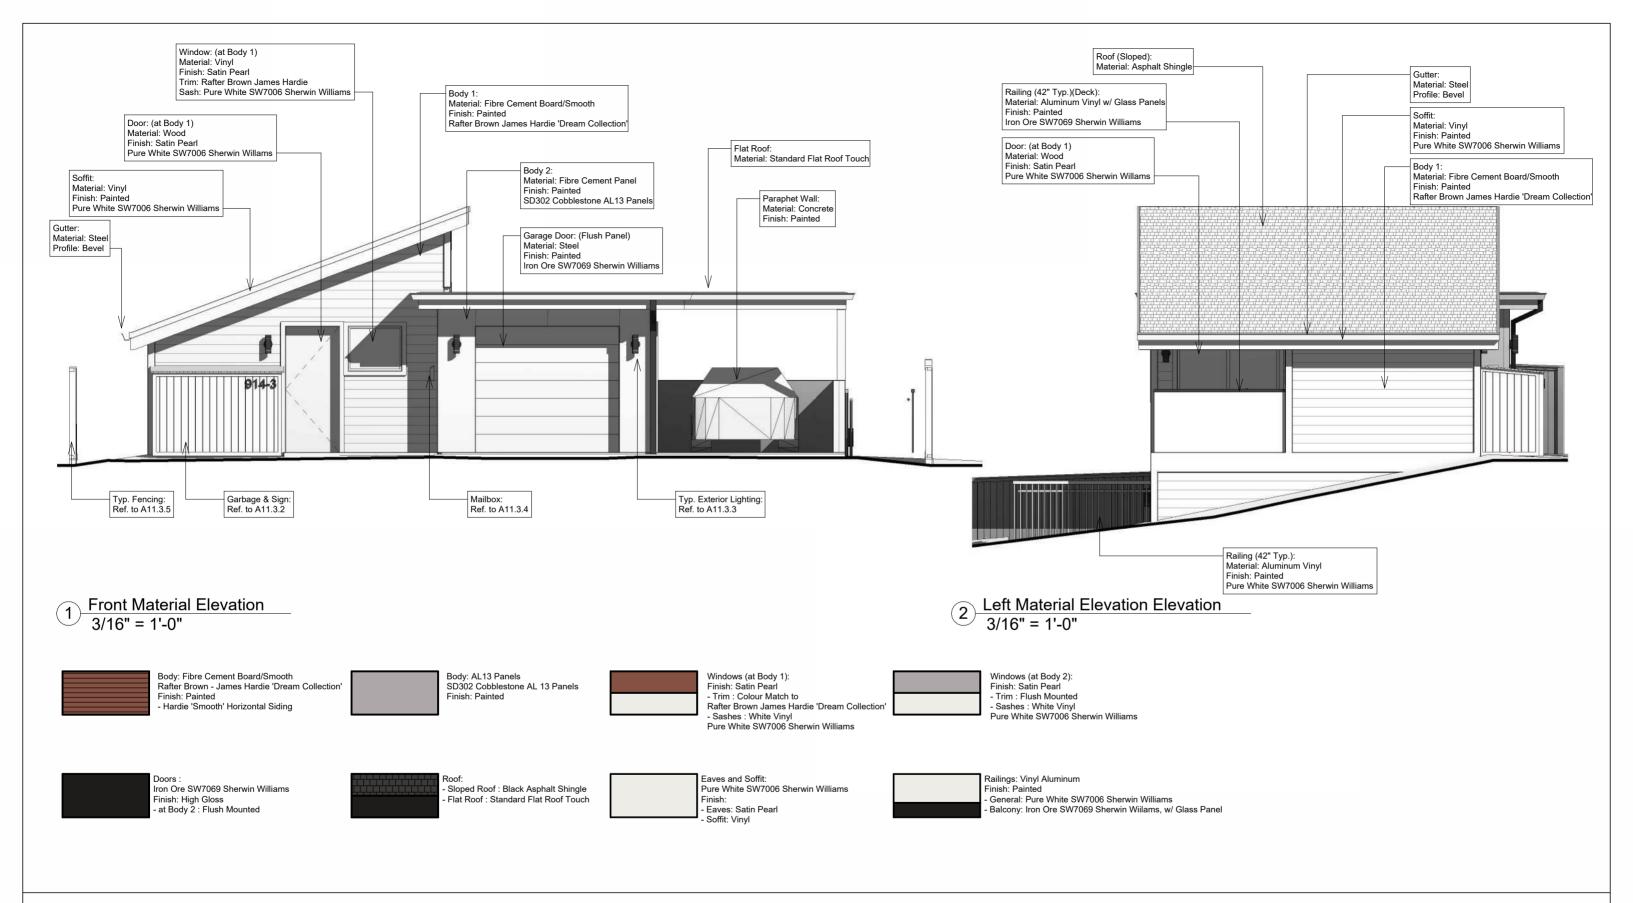

# Slivercrest Custom Homes and Reno

No.	Description	Date

Front and Left Materials			
Project number	1610		
Date	Oct 26, 2023	<sup>↑</sup> A21	
Drawn by	Author	, <b></b> .	
Checked by	Checker	Scale As indicated	

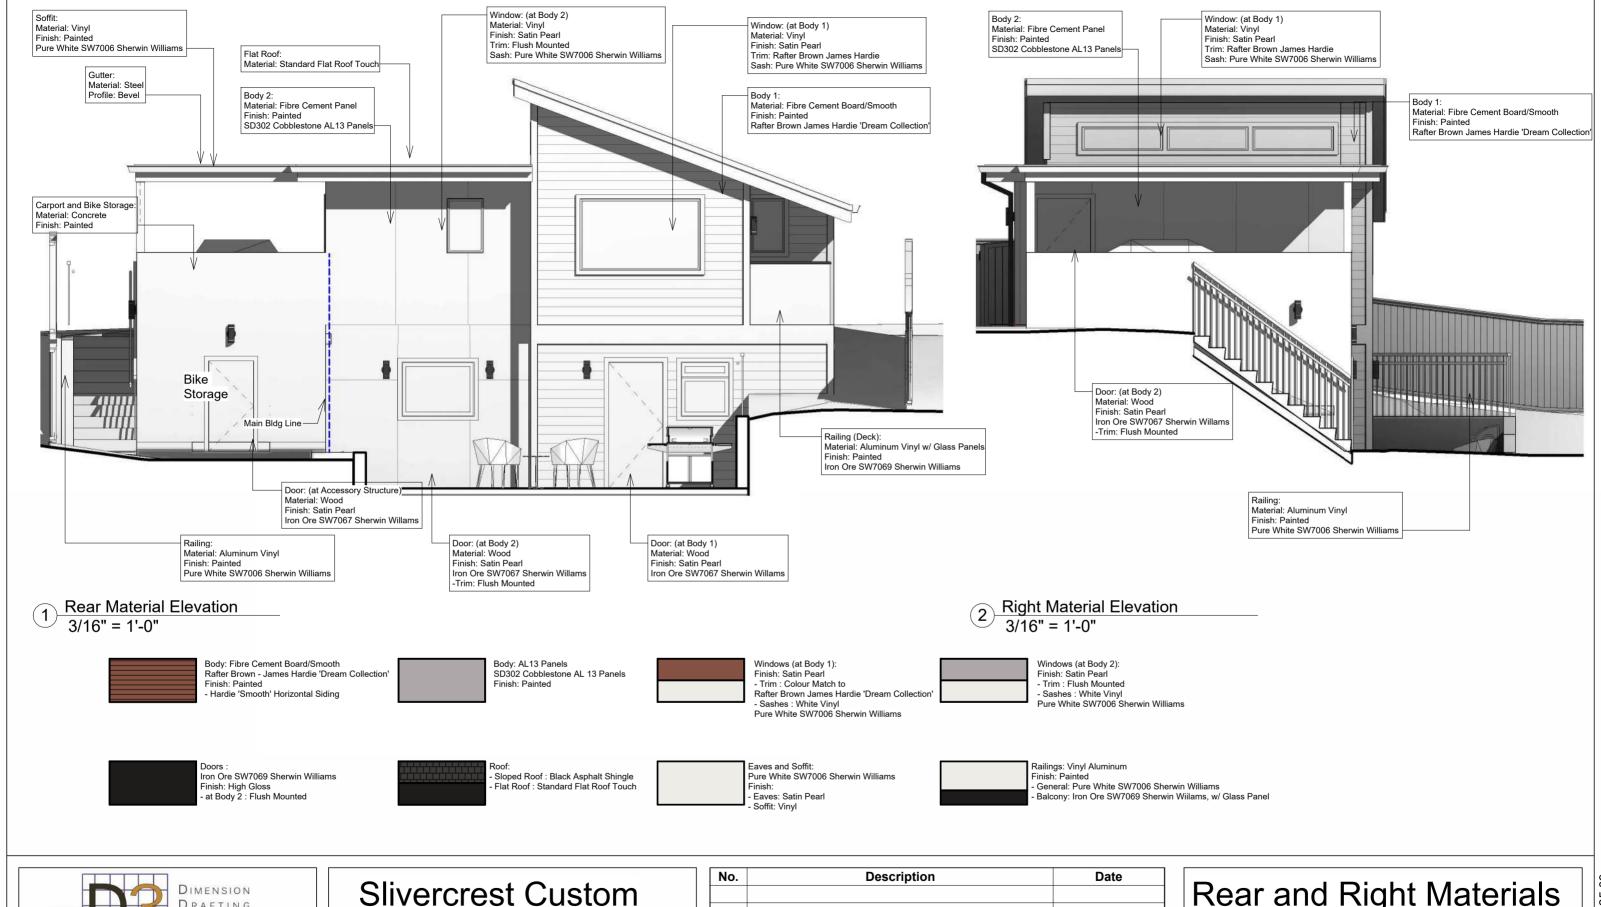




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Homes and Reno
914 Fourth Street

No.	Description	Date

Rear and Right Materials			1
Project number 1610			
Date	Oct 26, 2023	A22	
Drawn by	Author		
Checked by Checker Scale As indicated		-   (	
	·		;




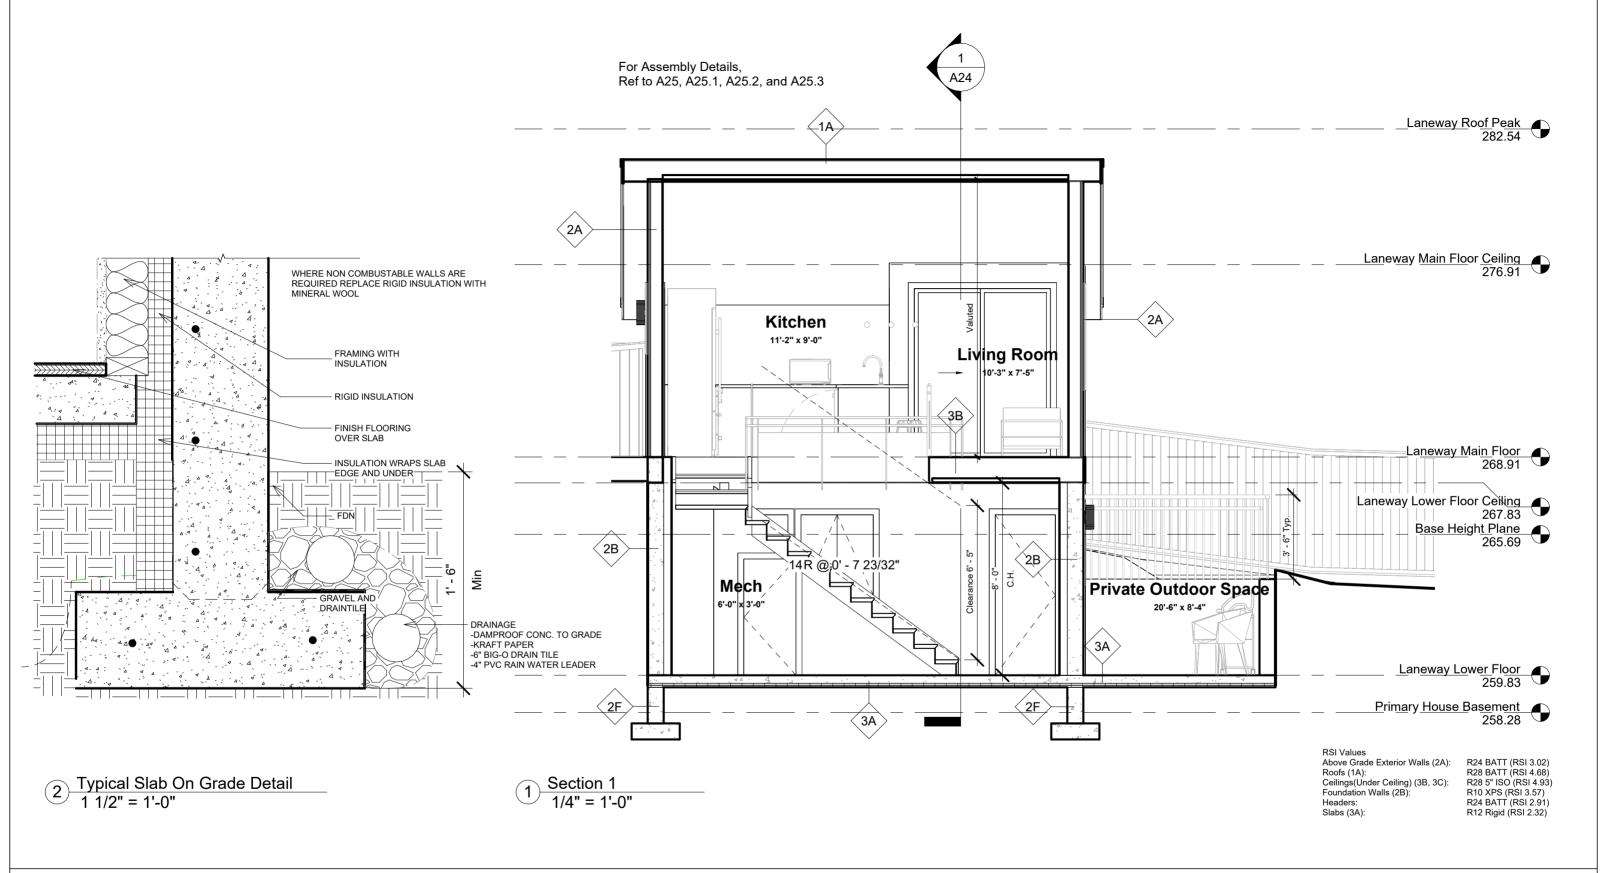

www.d3design.ca

No.	Description	Date

Section	tion 1		
Project number	Project number 1610		0
Date Oct 26, 2023 A23		3	
Drawn by	JG	,	ŀ
Checked by Checker Scale As indicated			ľ
			(

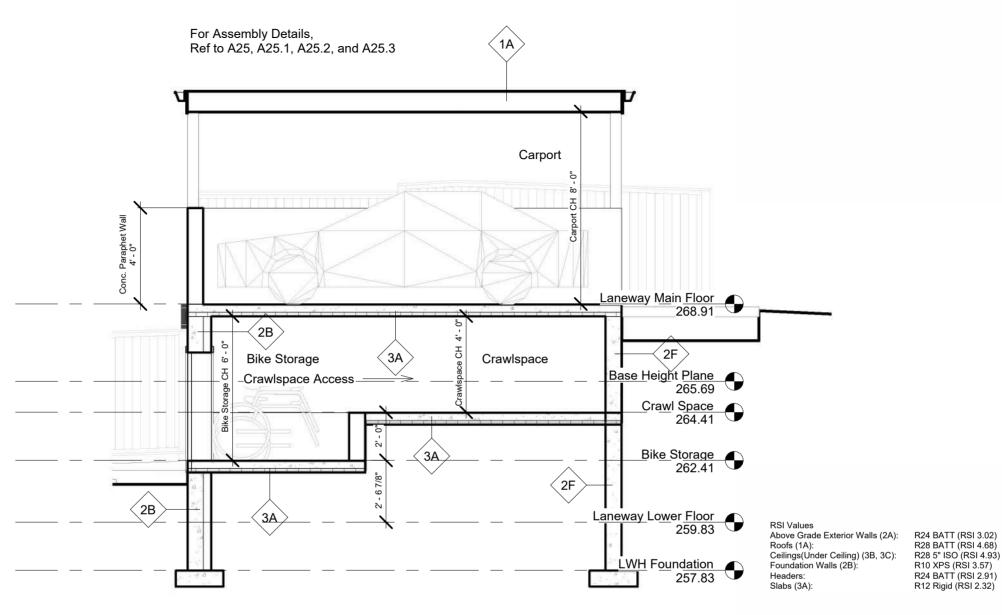

1) Crawlspace Section 1/4" = 1'-0"




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# Slivercrest Custom Homes and Reno

No.	Description	Date

Crawls	pace	Section	
	paoo		

Project number	1610	
Date	Oct 26, 2023	A23.1
Drawn by	Author	, , , , ,
Checked by	Checker	Scale 1/4" = 1'-0"



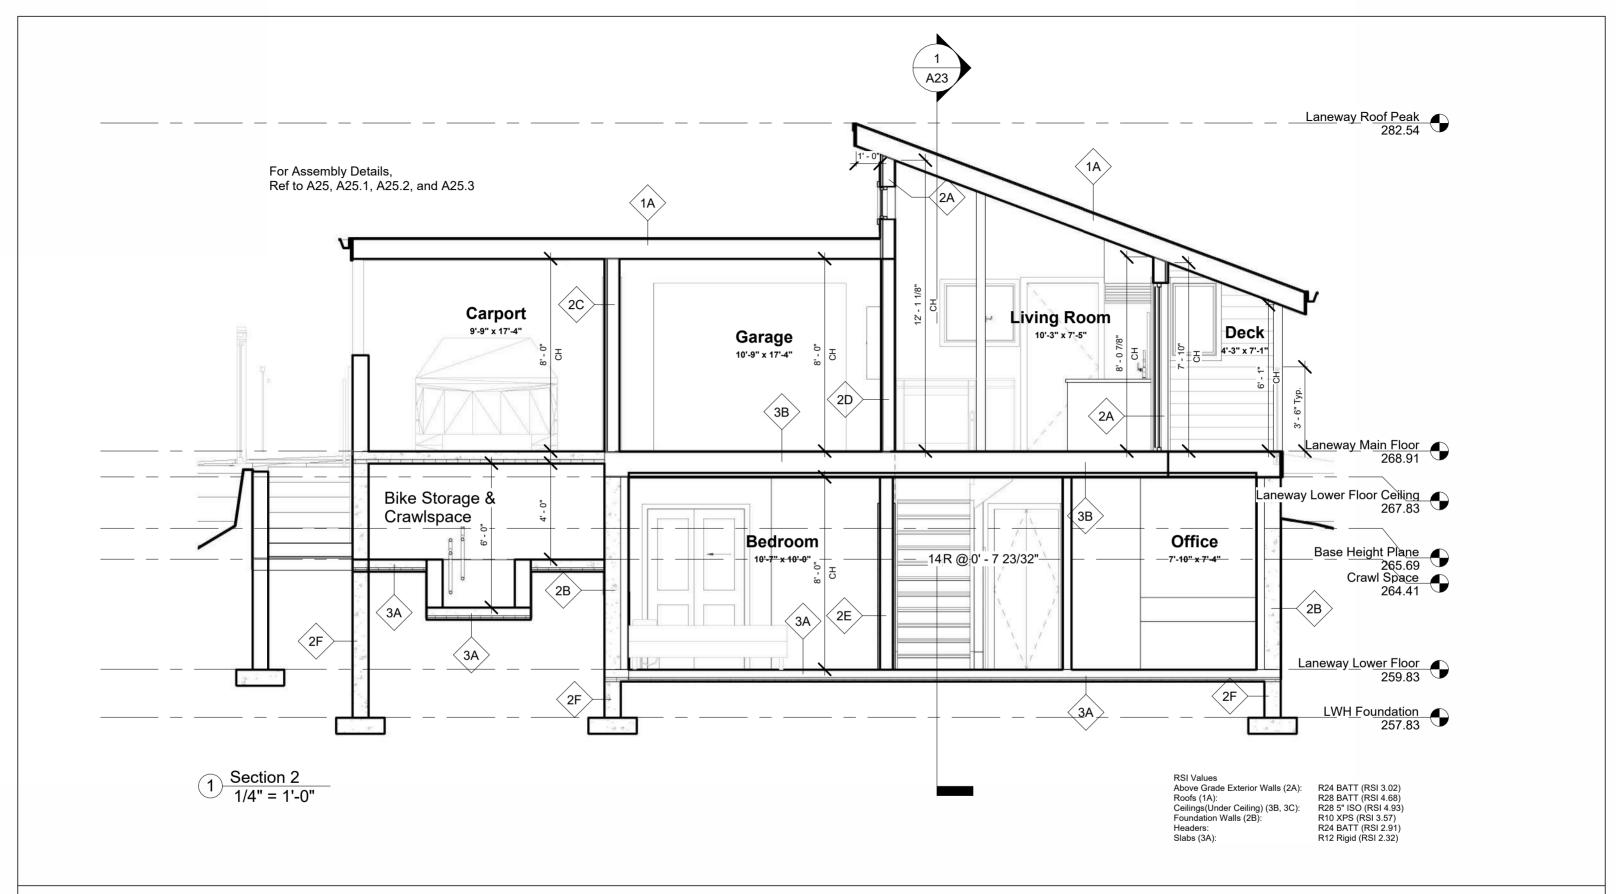

No.	Description	Date	

Section 2			
Project number 1610			
Date	Date Oct 26, 2023 A24		
Drawn by	JG	, <b></b> .	
Checked by	Checker	Scale 1/4" = 1'-0"	

#### TYPICAL CATHEDRAL ROOF & DECK 1A -BUILT UP ROOFING FOR LOW SLOPE APPLICATION -#15 ROOFING FELT -1/2" PLYWOOD SHEATHING -PROVIDE "H" CLIPS AT SEAMS (IF NEEDED) -ENG'D 2"x10" TRUSS @ 24" O.C. W/ R28 BATT INSULATION (RSI 4.68) -GUTTERS W/ GUTTER GUARDS -2"x6" SUB FASCIA -2"x8" SINGLE FACE COMB FASCIA -PERFORATED SOFFIT FINISH FOR CONTINUITY TYPICAL EAVE OVERHANG 1B -CONTINUE EAVE PROTECTION 12"INTERIOR FACE OF WALL -GUTTERS W/ GUTTER GUARDS -2"X6" SUB FASCIA -2"x8" SINGLE FACED COMB FASCIA -PERFORATED SOFFIT FINISH TO PROMOTE VENTILATION TYPICAL EXTERIOR WALLS 2A -CLADDING MATERIAL AS PER ELEVATIONS -RAIN SCREEN W/ MIN. 3/4" STRAPPING U.N.O. -BUILDING WRAP

-1/2" PLYWOOD SHEATHING -2x6 @ 16" O.C. W/ R24 BATT INSULATION (RSI 3.02) -6 MIL. POLY V.B. -1/2" GYPSUM WALL BOARD TYPICAL EXTERIOR FOUNDATION WALLS -8" ICF CONSTRUCTION -2" R10 XPS

-2x4 @ 16" O.C. W/ R14 BATT (RSI 3.57) -1/2" GYPSUM WALLBOARD **TYPICAL GARAGE EXTERIOR WALLS** 

-CONT. POLY V.B.

2B

2C

-CLADDING MATERIAL AS PER ELEVATION -RAIN SCREEN W/ MIN. 3/4" STRAPPING U.N.O. -BUILDING WRAP -1/2" PLYWOOD SHEATHING -2x6 @ 24" O.C. -6 MIL. POLY V.B. -1/2" GYPSUM WALLBOARD

TYPICAL GARAGE/DWELLING SEPERATION WALLS 2D -1/2" GYPSUM WALLBOARD -1/2" EXTERIOR RIGID INSULATION -2x6 @ 16" O.C. -1/2" GYPSUM WALLBOARD

#### TYPICAL INTERIOR PARTITION WALLS

-TYPE X GYPSUM WALL BOARD BOTH SIDES -2"x4" OR 2"X6" STUDS @ 16" O.C.

#### **TYPICAL FOUNDATION WALLS**

-8" ICF CONSTRUCTION -CONT. 6MIL POLY V.B. -GYPSUM WALLBOARD

2E

2F

3A

3B

3C

-ENG'D CONCRETE STRIP FOOTING -6" MIN. DRAIN ROCK

-4" PERIMETER DRAIN

TYPICAL S.O.G. FLOOR

-FINISH FLOORING -4" CONCRETE SLAB (UNHEATED)

-R12 RIGID INSULATION (RSI 2.32)

-COARSE, CLEAN GRANULAR FILL (CAPILLARY BREAK)

-UNDISTURBED SOIL

-1" GAP BETWEEN SLAB AND FOUNDATION WALL FILLED W/EXTRUDED POLYSTYRENE AGAINST WALL

-SFALANT

-EXTEND DAMPROOFING TO EDGE OF FOOTING AND UNDER WALL AS CAPILLARY BREAK

#### TYPICAL WOOD FLOOR (SUSPENDED)

-FINISH FLOORING

-1/2" T&G PLYWOOD SHEATHING (GLUED & NAILED)

-11 7/8 TJI JOISTS @ 16" O.C. W/ R-28 5" ISO (RSI 4.93)

-G.W.B. FOR UNDERSIDE OF JOISTS

TYPICAL DECK FLOOR (SUSPENDED)

-FINISH FLOORING

-1/2" T&G PLYWOOD SHEATHING (GLUED & NAILED) -6MIL POLY V.B.

-11 7/8" TJI JOISTS W/ R-28 5" ISO (RSI 4.93) -G.W.B. FOR UNDERSIDE OF JOISTS

**FENESTRATION** 

-DOORS TO BE USI 1.8 OR BETTER -WINDOWS TO BE USI 1.4 OR BETTER

-0.35 SHGC OR BETTER

#### **IMPORTANT NOTE:**

THIS SET OF DRAWINGS WAS CAREFULLY PRODUCED AND CHECKED BY D3 DIMENSION DESIGN DRAFTING LTD. AND IN WHOSE OPINION WHEN RELEASED ME THE RESTRICTIONS AND THE REQUIREMENTS OF THE CURRENT BC BUILDING CODE HOWEVER DUE TO OUR OVERSIGHT OR DUE TO OTHERS CHANGING OR AUGMENTING THE PLAN WITH STRUCTURAL INFORMATION SHOULD ANY LINTEL, BEAM, FOOTING, OR ANY OTHER STRUCTURAL ASPECT(S) OF THIS SET OF DRAWINGS BE INCORRECTLY POSITIONED, SIZED, SPECIFIED, OR BEYOND THE SCOPE OF THE BUILDING CODE HAVING JURISDICTION. THE COMPLETE SET OF DRAWINGS MUST BE CHECKED, SIGNED, DATED, AND SEALED BY A QUALIFIED CERTIFIED STRUCTURAL ENGINEER.

#### **ATTENTION STRUCTURAL ENGINEER:**

A STRUCTURAL ENGINEER IS REQUIRED TO PROVIDE SEISMIC SOUTIONS AND CERTIFY THIUS DESIGN UNDER PART 4 OR THE B.C. BUILDING CODE 2018 ED. ALL STRUCTURAL ENGINEERING MUST BE ON A SEPERATE SET OF DRAWINGS PRODUCED BY THE ENGINEER.

THESE PLANS CONFORM TO THE B.C. BUILDING CODE 2018 ED.

#### THESE DETAIL DRAWING COPIES OR ANY COPIES THEREOF:

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#### Proposed Assemblies to Comply with BC Energy Step Code 3

RSI Values Above Grade Exterior Walls (2A): R24 BATT (RSI 3.02) Roofs (1A): R28 BATT (RSI 4.68) Ceilings(Under Ceiling) (3B, 3C): R28 5" ISO (RSI 4.93) Foundation Walls (2B): R10 XPS (RSI 3.57) R24 BATT (RSI 2.91) Slabs (3A) R12 Rigid (RSI 2.32)




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# Slivercrest Custom Homes and Reno

No.	Description	Date


nblies		
1610		
Oct 26, 2023	A25	
Author		
Checker	Scale 3" = 1'-0"	
	Oct 26, 2023 Author	1610 Oct 26, 2023 Author

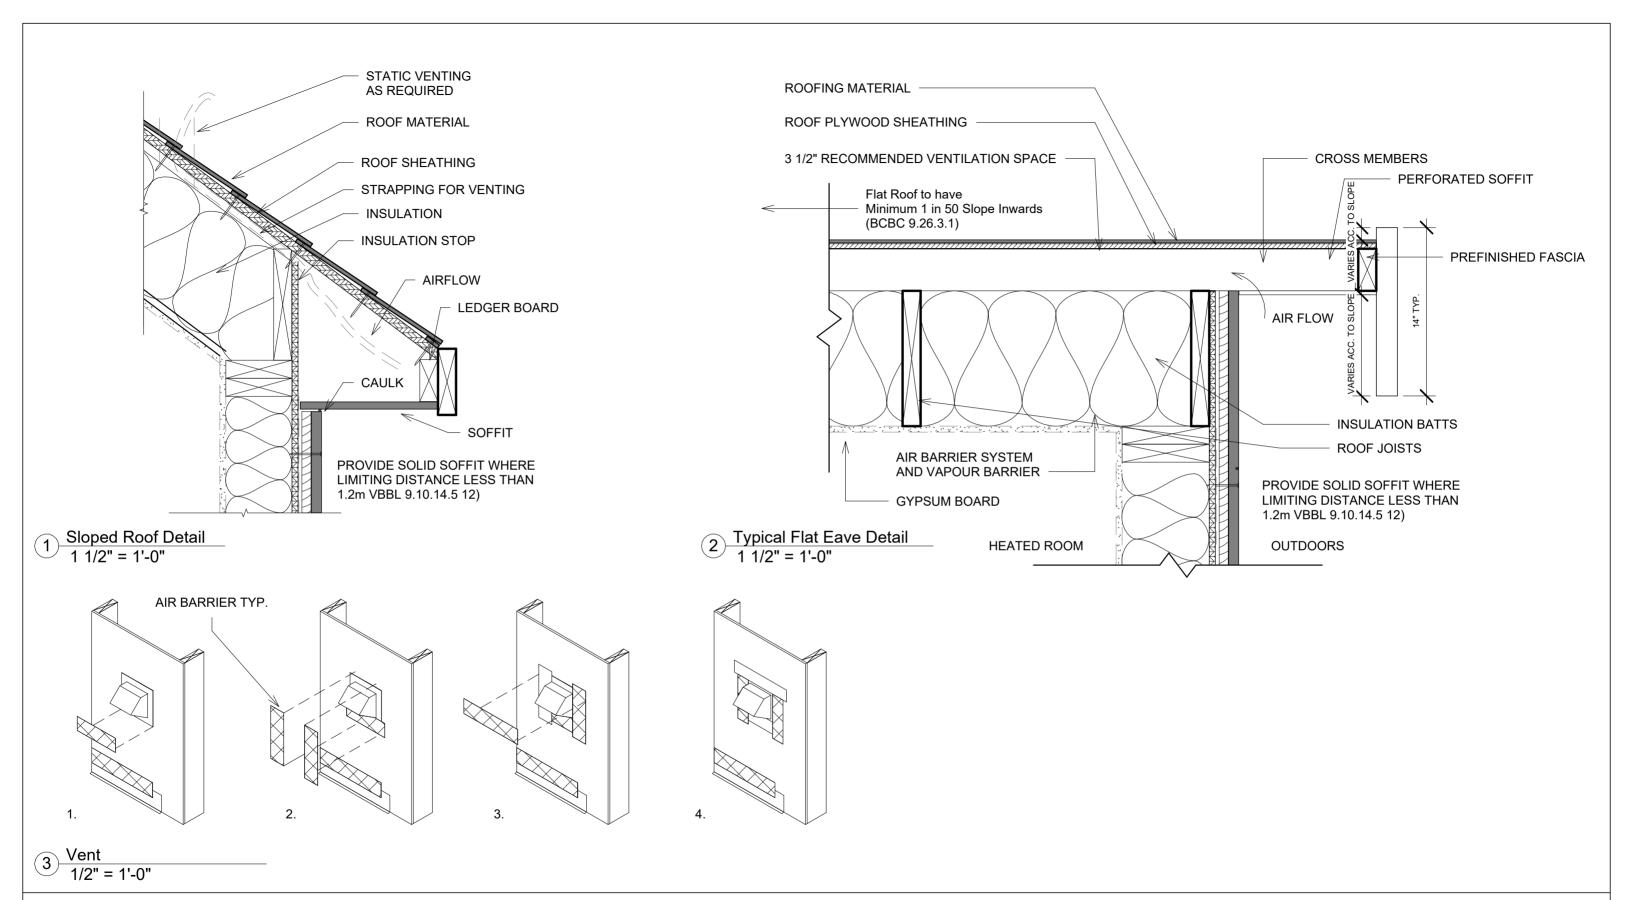


D3	DIMENSION DRAFTING DESIGN INC.
	ew Westminster, BC V3M4N2 .d3design.ca

No.	Description	Date


Details	s 1		
Project number	1610	10-1	
Date	Oct 26, 2023	□ A25.1	
Drawn by	KM	, (=0	
Checked by	Checker	Scale As indicated	
			]

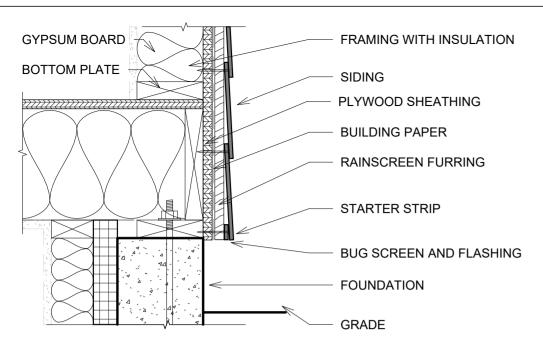



Foundation Floor Wall connection Detail
1 1/2" = 1'-0"

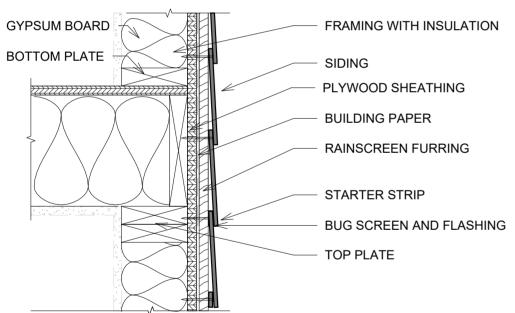


2 Floor Wall connection Detail 1 1/2" = 1'-0"

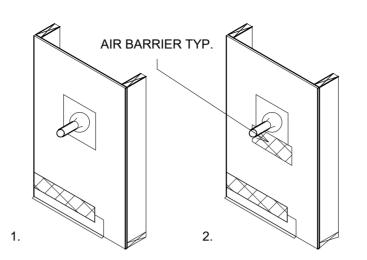

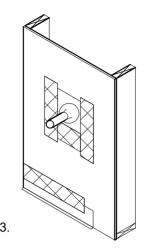

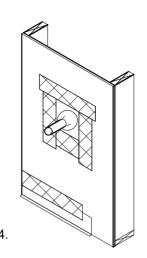

3 Hose Bib 1/2" = 1'-0"

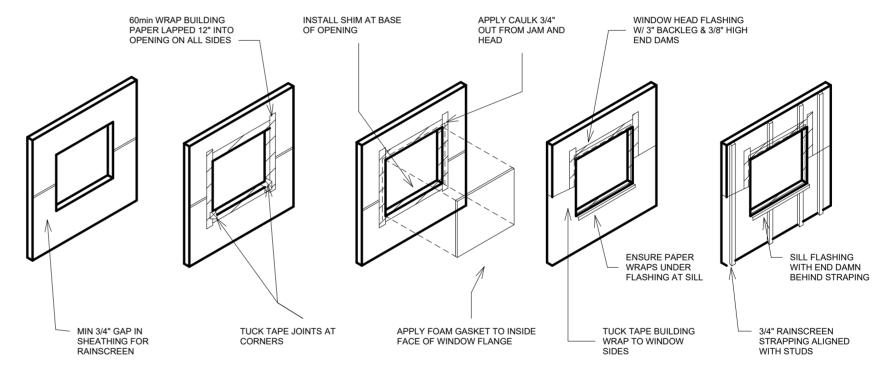

4 Rainscreen 1/2" = 1'-0"




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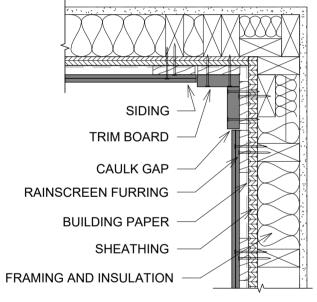
# Slivercrest Custom Homes and Reno


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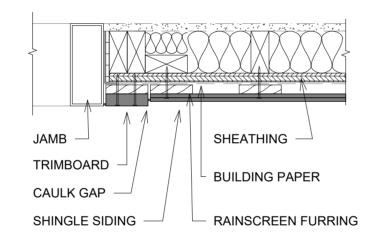
Details 2		
Project number	1610	
Date	Oct 26, 2023	A25.2
Drawn by	Author	, .=312
Checked by	Checker	Scale As indicated

27-Oct-2023 04:25:17





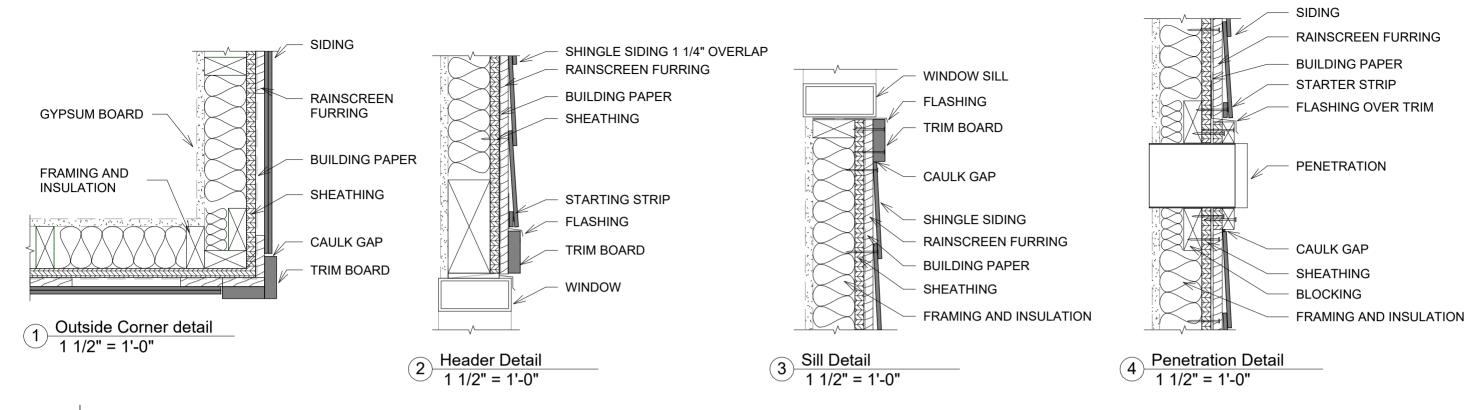

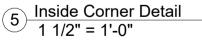

6 Jam detail 1 1/2" = 1'-0"



# Slivercrest Custom Homes and Reno

No.	Description	Date

Details	s 3		
Project number	1610		
Date	Oct 26, 2023	A25.3	
Drawn by	KM	, (2010	
Checked by	Checker	Scale 1 1/2" = 1'-0"	

27-Oct-2023 04:25:17





# Slivercrest Custom Homes and Reno

No.	Description	Date

Project number	1610	1.00
Date	Oct 26, 2023	A26
Drawn by	Author	,
Checked by	Checker	Scale









## Slivercrest Custom Homes and Reno 914 Fourth Street

No.	Description	Date


Lanew	ay 3D Vi	ews
Project number	1610	
Date	Oct 26, 2023	A26.1
Drawn by	JG	, , , ,

Scale

Checked by

JG

27-Oct-2023 04:25:40

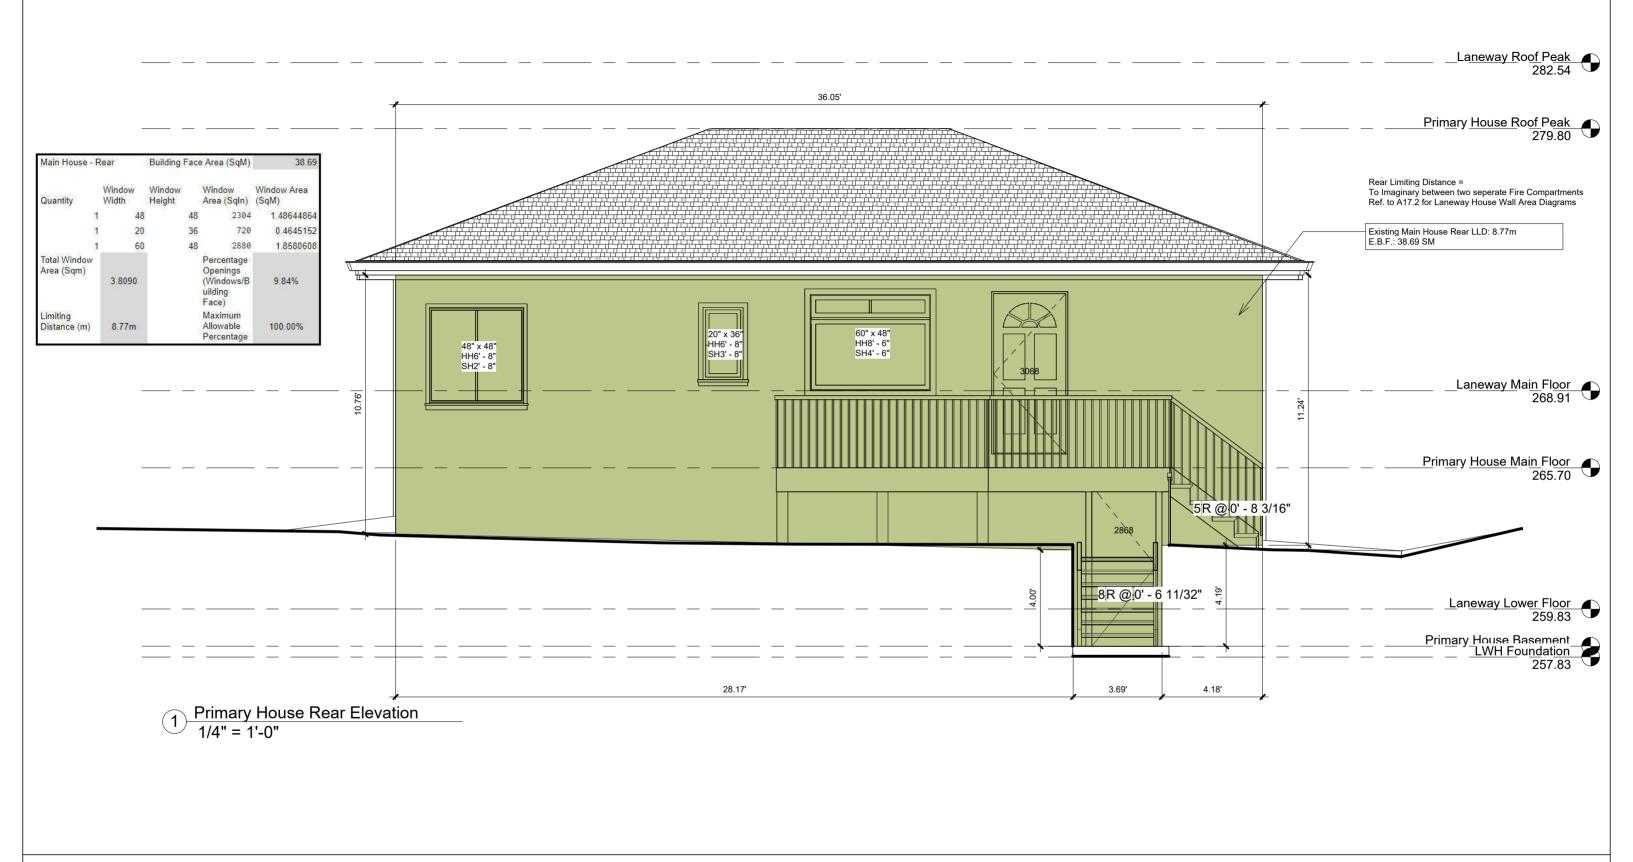



No.	Description	Date

Main House Rear		
1610		
Oct 26, 2023	A27	
Author	, <b></b> .	
Checker	Scale 1/4" = 1'-0"	
	1610 Oct 26, 2023 Author	





# Slivercrest Custom Homes and Reno

914 Fourth Street

No.	Description	Date

# Main House Rear Photos

roject number	1610	10-1
ate	Oct 26, 2023	A27.1
rawn by	Author	,
hecked by	Checker	Scale



# Slivercrest Custom Homes and Reno

914 Fourth Street


No.	Description	Date
28	Tree protection information update.	July 13, 2023
30	Site service plan update according to the city revision. Aug 1, 2023	Aug 1, 2023
31	Existing fence detail corrected to existing fence to be Aug 4, 2023	Aug 4, 2023
	kept identified at the site service plan.	
33	Service connection changed to North East Corner	October 16, 20

Site Service	ervice Plan	an ne
Project number	1610	•
Date	Oct 26, 2023	
Drawn by	Author	i
Checked by	Checker	Scale 1/16" = 1'-0"






## **Fourth Street**

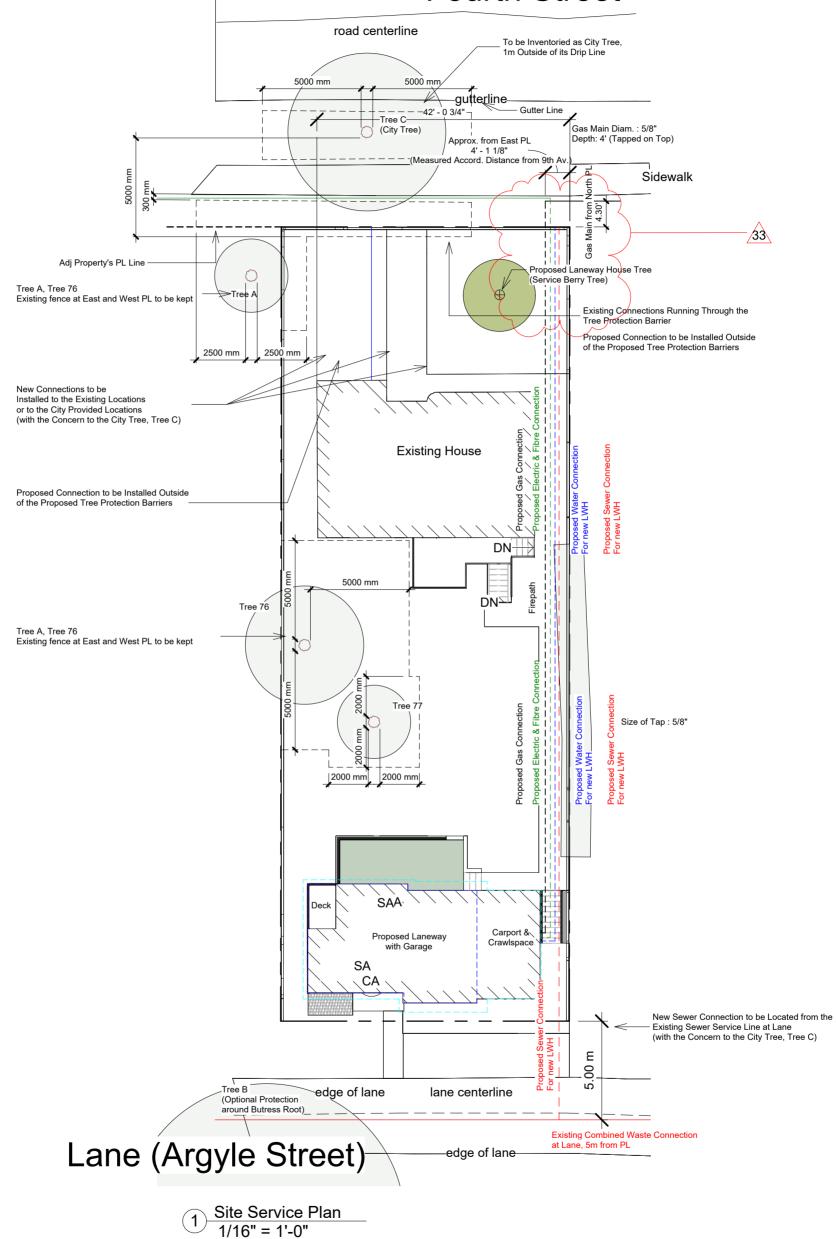

Plumbing Fixtures are Restricted as Follows:

A) All Sanitary Fixtures (including Drains) with Rim Elevations below 51.73m (geodetic) or 169.718 ft (geodetic) must be Protected. (see the "Fixture Restriction Guidelines Update" attached)

B) All Storm Fixtures with Rim Elevations below 51.73m (geodetic) or 169.718 ft (geodetic) must be Protected (see the "Fixture Restriction Guidelines Update" attached)

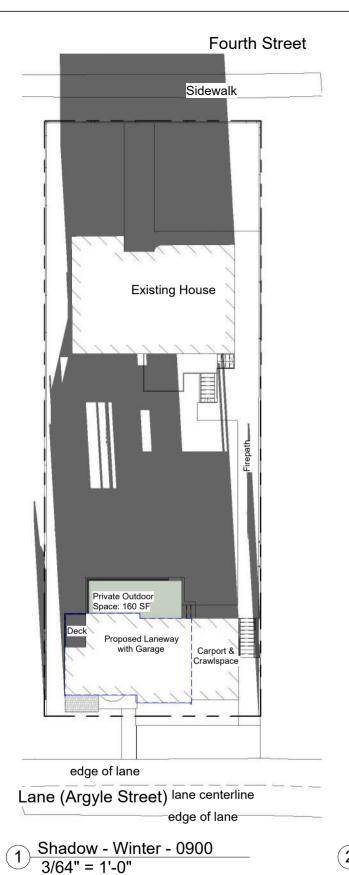

Fourth Street Sidewalk **Existing House** Private Outdoor Space: 160 SF Proposed Laneway Carport & edge of lane Lane (Argyle Street) lane centerline

**Existing House** DN Private Outdoor Space: 160 SF Carport & edge of lane Lane (Argyle Street) lane centerline

Fourth Street

Sidewalk

Shadow - Winter - 1500 3/64" = 1'-0"






Shadow - Winter - 1200 3/64" = 1'-0"



## Slivercrest Custom Homes and Reno 914 Fourth Street

No.	Description	Date

Shadow Study Winter		
1610		
Oct 26, 2023	A29	
Author	,	
Checker	Scale 3/64" = 1'-0"	
	1610 Oct 26, 2023 Author	

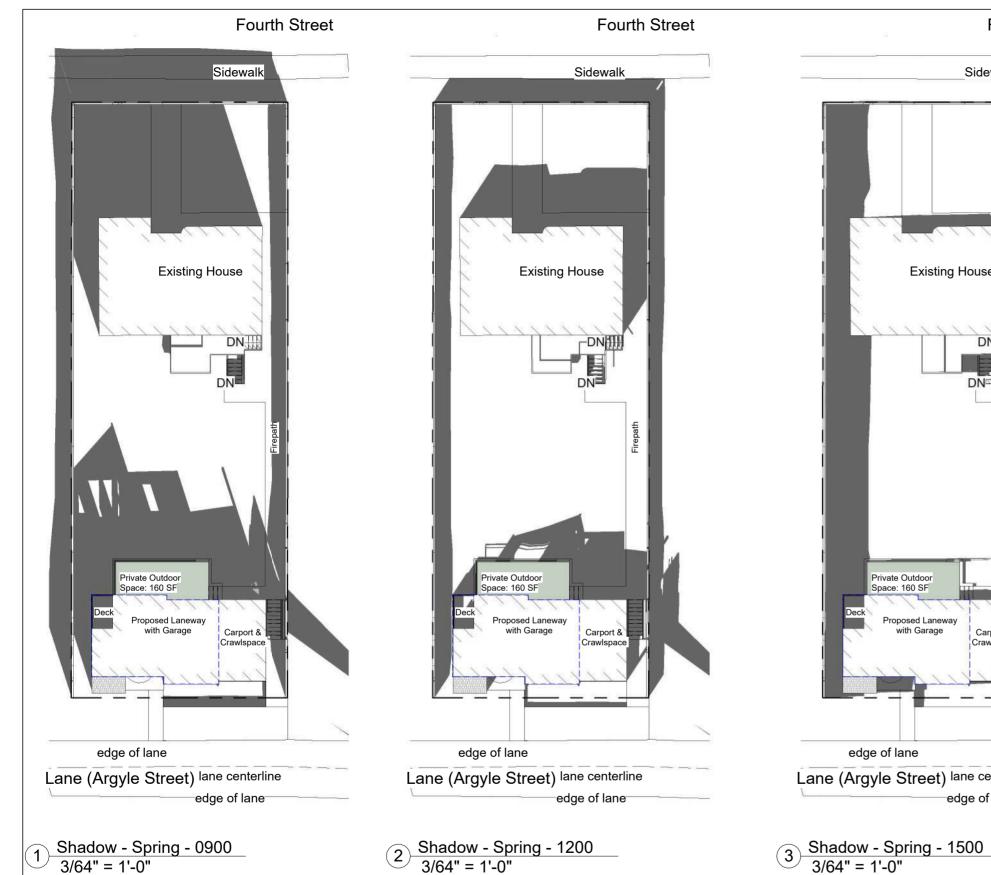

**Existing House** Space: 160 SF Proposed Laneway Carport & edge of lane Lane (Argyle Street) lane centerline edge of lane

Fourth Street

Sidewalk

Shadow - Spring - 1800 3/64" = 1'-0"



Fourth Street






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www.d3design.ca

## Slivercrest Custom Homes and Reno 914 Fourth Street

No.	Description	Date

Shadow Study Spring		
Project number	1610	
Date	Oct 26, 2023	A30
Orawn by	Author	, 100
Checked by	Checker	Scale 3/64" = 1'-0"

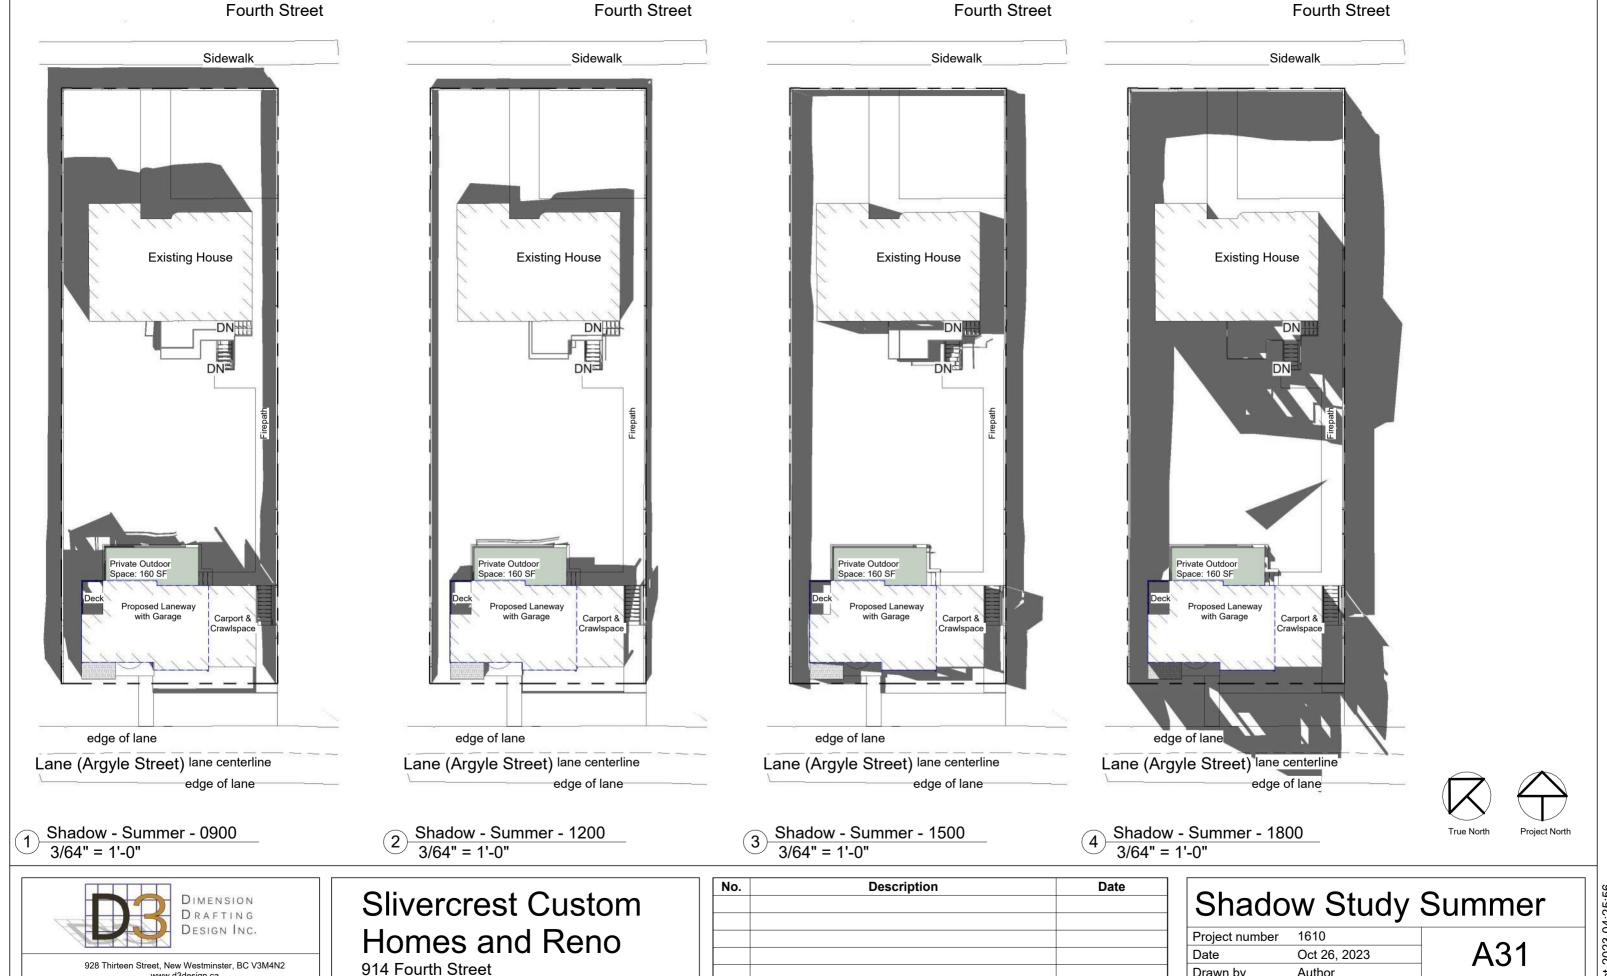

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27-Oct-2023 04:25:56

Scale 3/64" = 1'-0"

Author

Checker

Drawn by

Checked by




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Slivercrest Custom Homes and Reno 914 Fourth Street

No.	Description	Date

Shadow Study Fall			
Project number	1610	1 0 0	
Date	Oct 26, 2023	A32	
Drawn by	Author	, , , ,	
Checked by	Checker	Scale 3/64" = 1'-0"	'



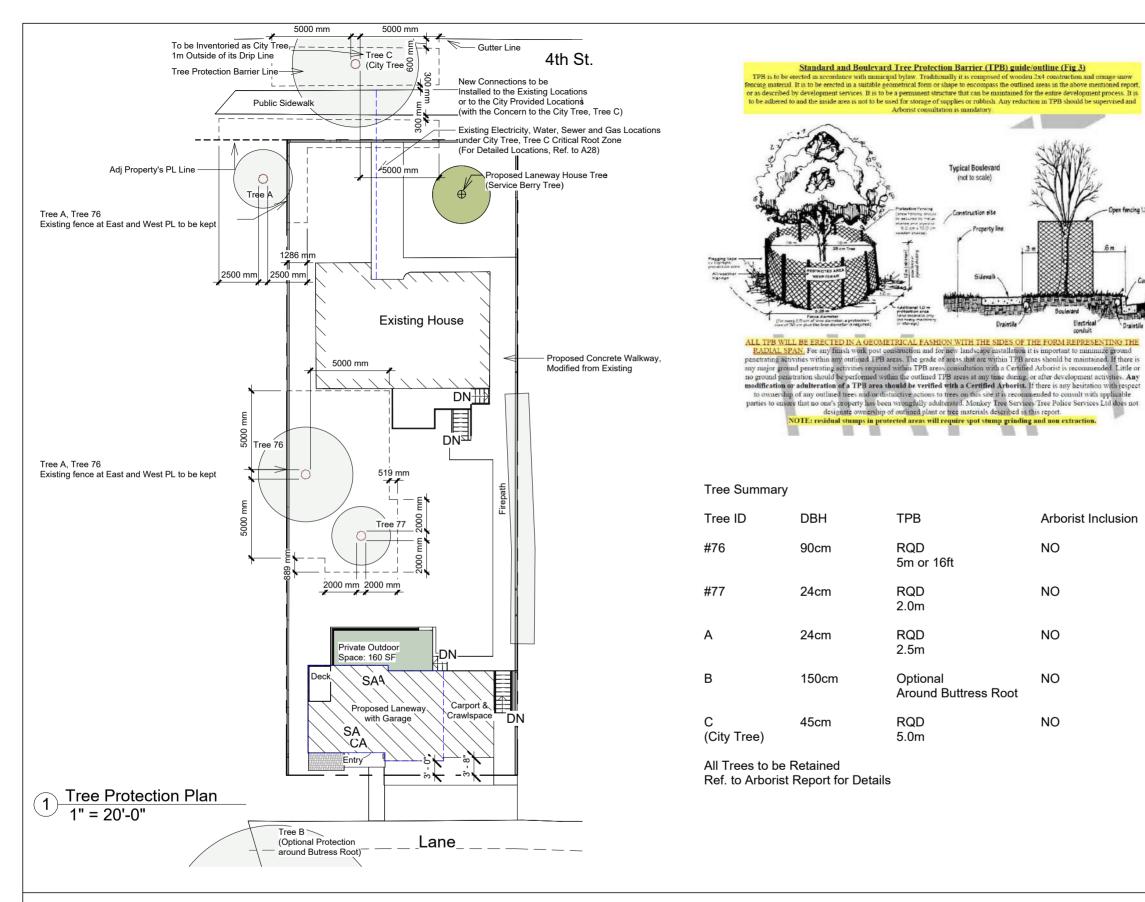

## **Slivercrest Custom** Homes and Reno 914 Fourth Street

No.	Description	Date
28	Tree protection information update.	July 13, 2023
31	Existing fence detail corrected to existing fence to be kept identified at the site service plan.	Aug 4, 2023

Arborist Inclusion

NO

NO

NO

NO

NO

Tree Protection Plan			
Project number	1610		
Date	Oct 26, 2023	A33	
Drawn by	KM		
Checked by	Checker	Scale 1" = 20'-0"	
			- 1